
Attachment 'D'

SHEET NO.	DESCRIPTION	REVISION
G-0001	COVER SHEET	2
G-0002	CONCEPTUAL RENDERINGS	
V-1001	EXISTING SITE CONDITIONS	
A-1001	SITE PLAN	2
A-1002	DETAILS	2
A-1003	DETAILS	2
A-1004	LAYOUT AND EXTERIOR ELEVATIONS-24'X24' SHED	
C-2001	CIVIL GRADING AND DRAINAGE PLAN	2
C-2002	FENCE DETAILS	
C-2003	FENCE DETAILS	
C-2004	CIVIL DETAILS	
C-3001	WATER & SEWER PLAN	
C-4001	CONSTRUCTION EROSION AND SEDIMENT CONTROL PLAN	
C-4002	EROSION AND SEDIMENT CONTROL NOTES	
E~1001	ELECTRICAL SITE PLAN	
E-1002	LIGHTING PHOTOMETRIC PLAN	
L-1001	LANDSCAPE PLAN	2
L-1002	TYPICAL PLANTING DETAILS	
LS-1001	LIFE SAFETY PLAN	2

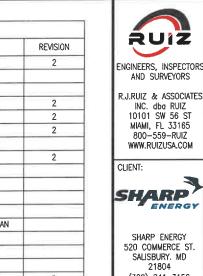

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NGINEERS, INSPECTORS

INC. dba RUIZ 10101 SW 56 ST MIAMI, FL 33165 800-559-RUIZ WWW.RUIZUSA.COM


SALISBURY, MD (302) 841-3156

DATE: 10/16/2025 APPROVED BY: RUIZ CONTROL: 25-1770

NW 16TH ST I

SHEET NO:

G-0001

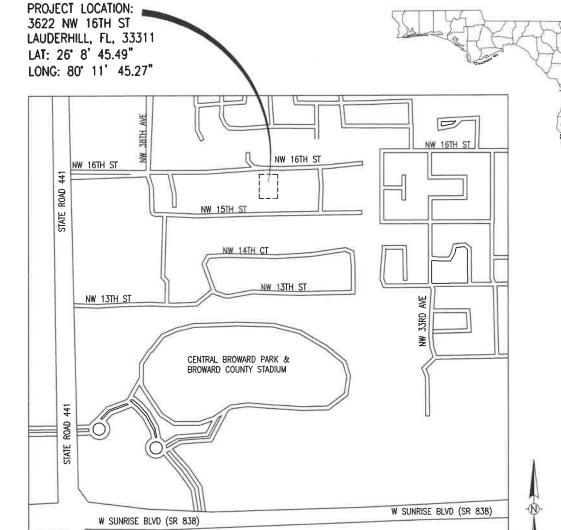

VICINITY MAP

520 COMMERCE STREET SAUSBURY, MD 21804 (302) 841-3156 WWW.SHARPENERGY.COM

SHARP ENERGY / BOYE'S GAS SERVICE INC

3622 NW 16TH ST LAUDERHILL, FL33311

LAUDERHILL PROPANE BULK STORAGE YARD

**ISSUED FOR PERMITTING** Monday, November 10, 2025

BROWARD COUNTY

PREPARED BY THE OFFICE OF:

LIABILITY TO R.J. RUIZ AND ASSOCIATES, INC.

R.J. RUIZ AND ASSOCIATES, INC. dba RUIZ ENGINEERS || INSPECTORS || SURVEYORS 10101 SW 56TH STREET MIAMI, FLORIDA 33165

THIS DOCUMENT, TOGETHER WITH THE CONCEPTS AND DESIGNS PRESENTED HEREIN, AS AN INSTRUMENT OF SERVICES, IS INTENDED ONLY FOR THE SPECIFIC PURPOSE AND CLIENT FOR WHICH IT WAS PREPARED. REUSE AND

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AND ADAPTATION BY R.J. RUIZ AND ASSOCIATES, INC. SHALL BE WITHOUT

**PLANNING & ZONING DIVISION** 

NOV 12 2025

# RECEIVED

Roland J Digitally signed by Roland J Ruiz Date: 2025.11.10

AND SEALED BY ROLAND JESUS RUIZ ON THE DATE ADJACENT TO THE SEAL. PRINTED COPIES OF THIS DOCUMENT ARE NOT CONSIDERED SIGNED AND SEALED AND THE SIGNATURE MUST BE VERIFIED ON ANY ELECTRONIC COPIES





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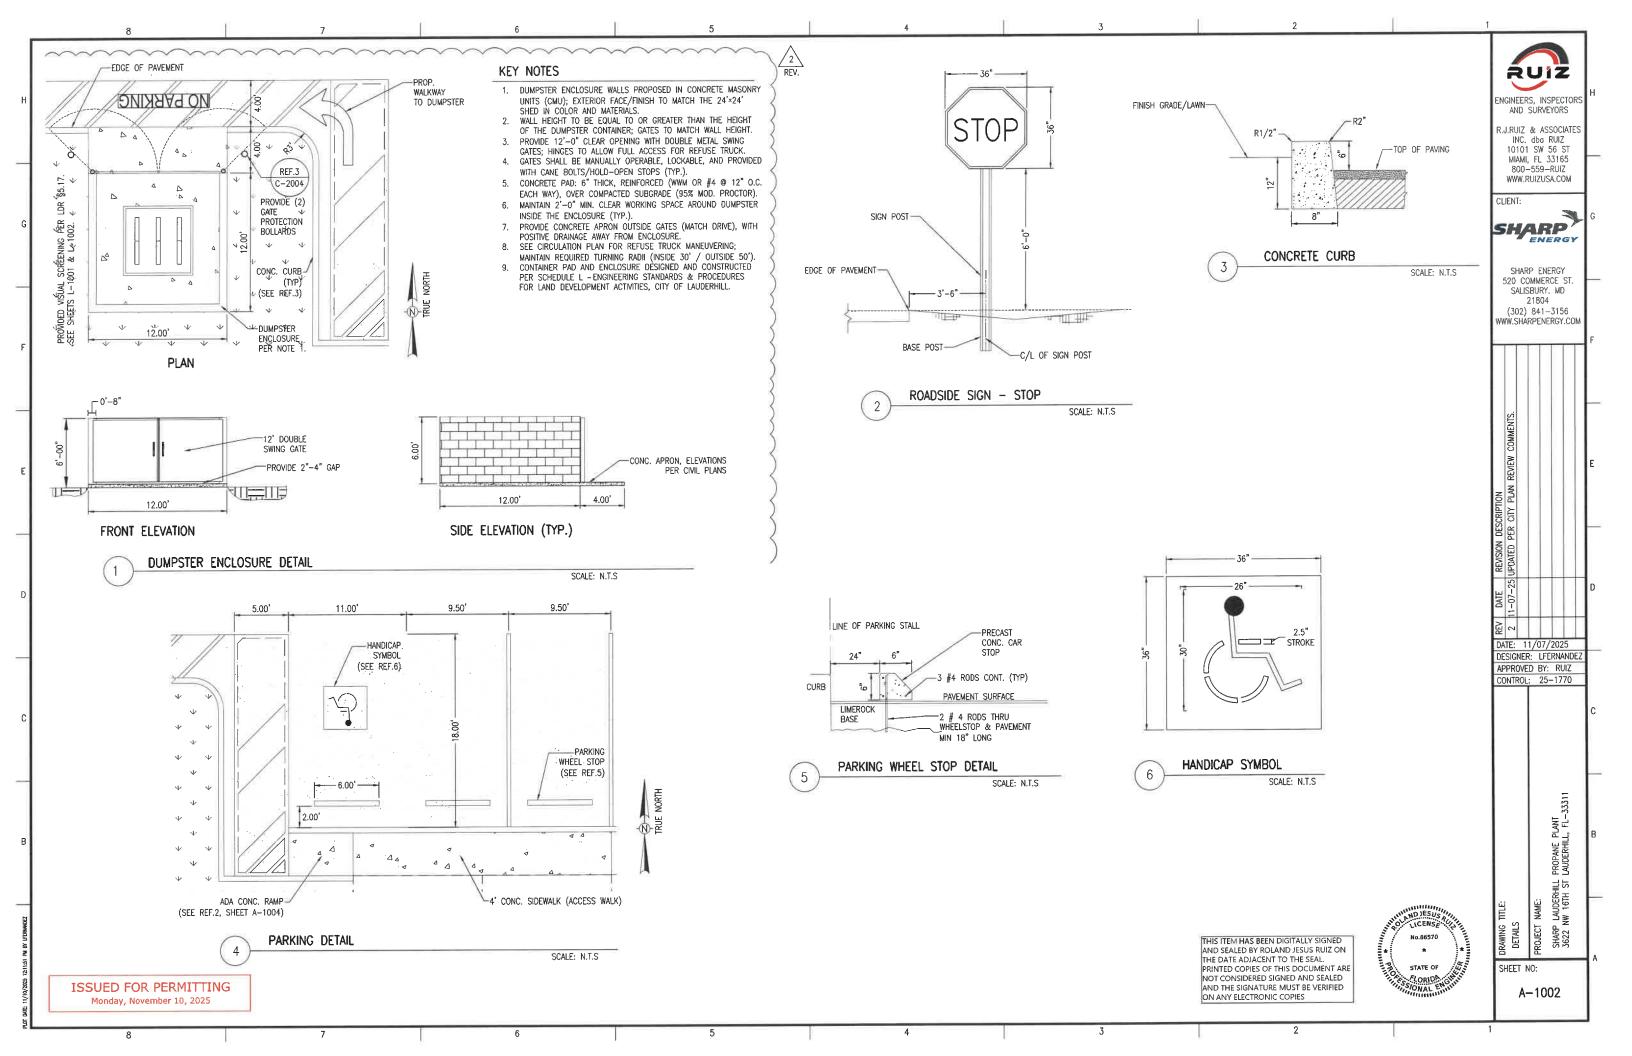
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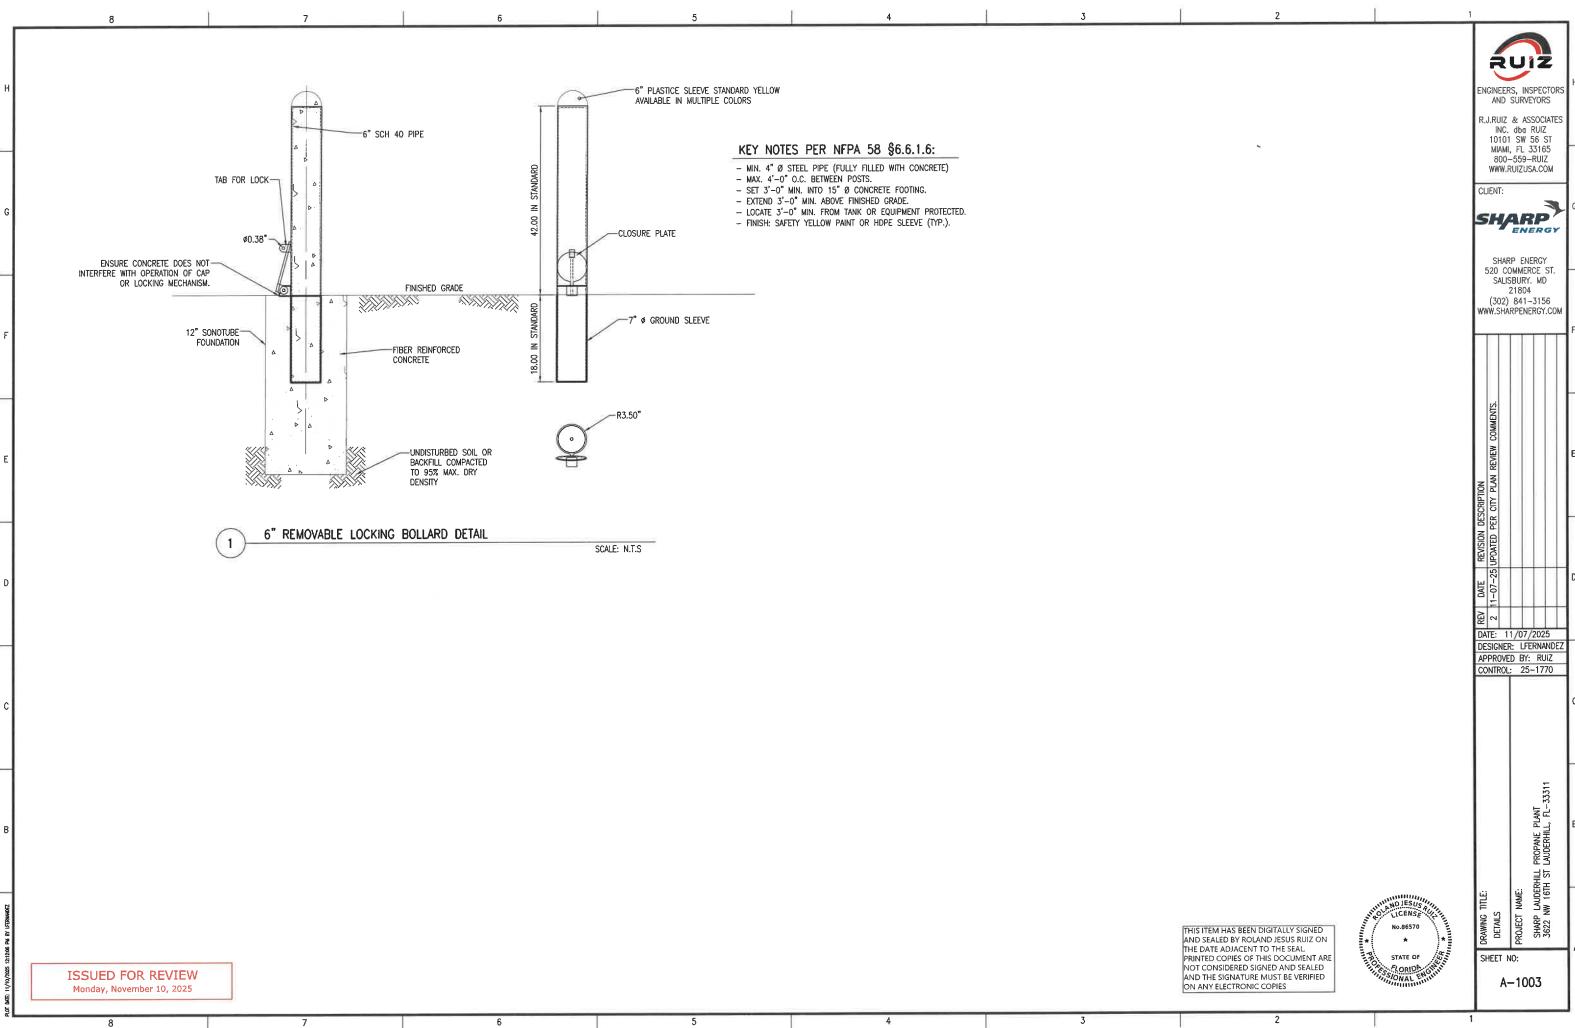
Call before you dig.









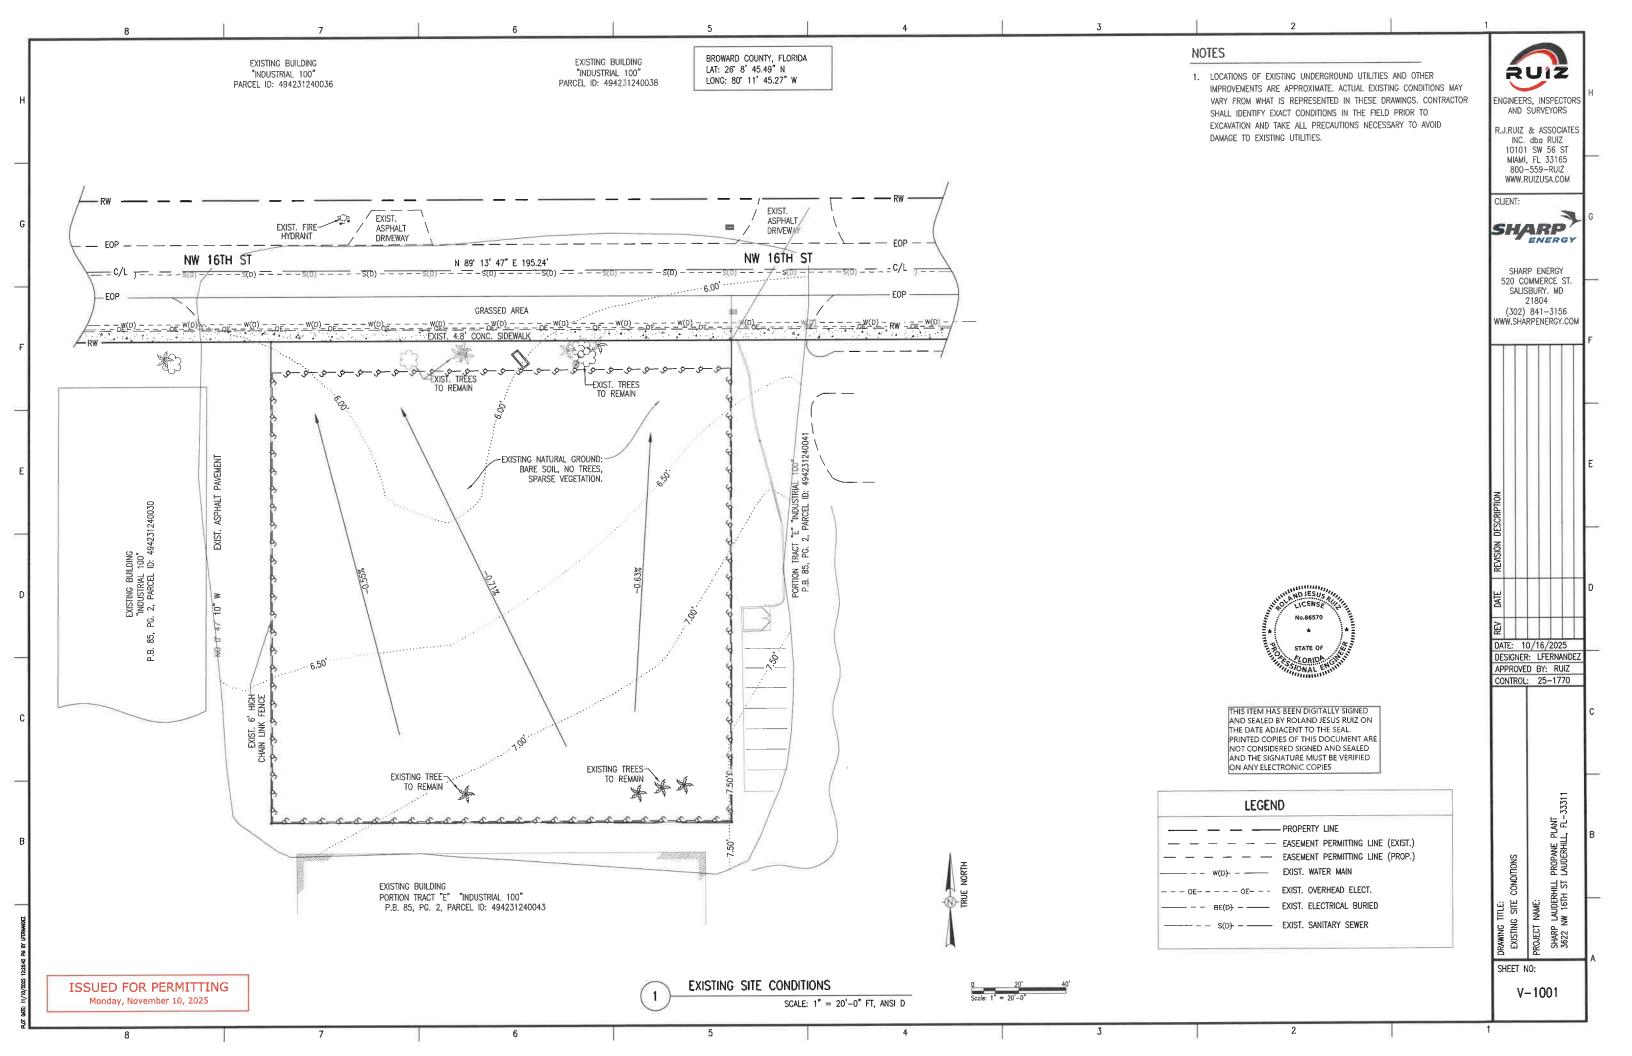

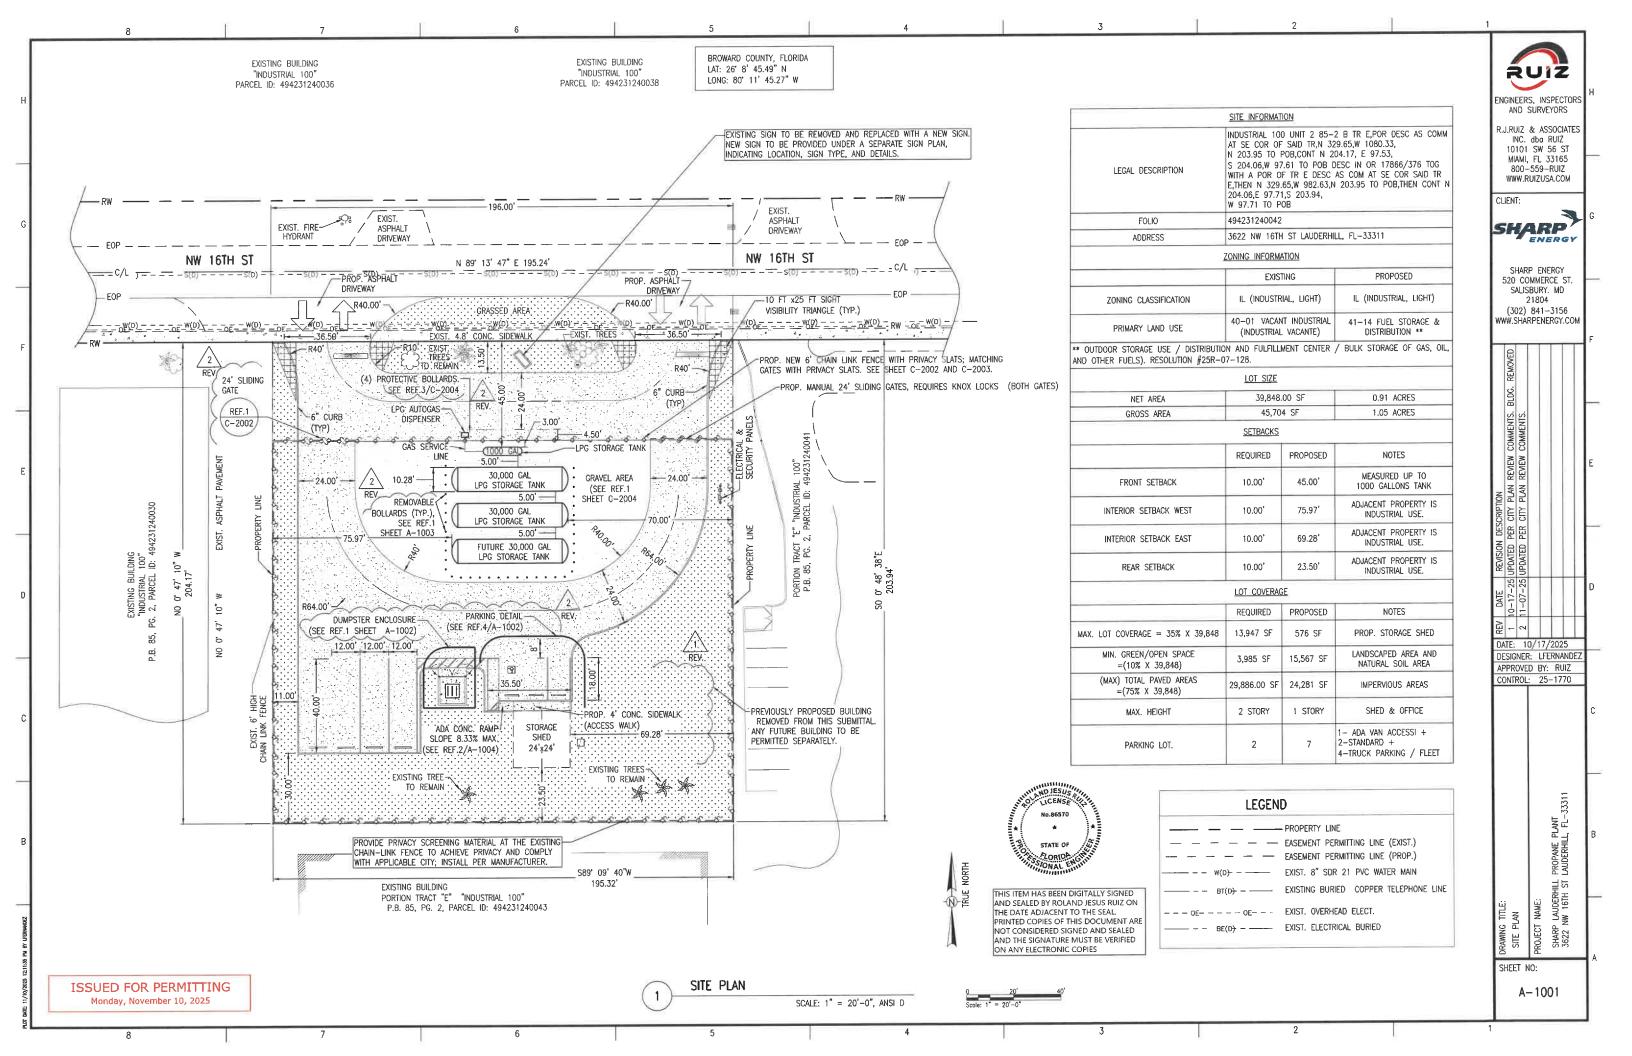

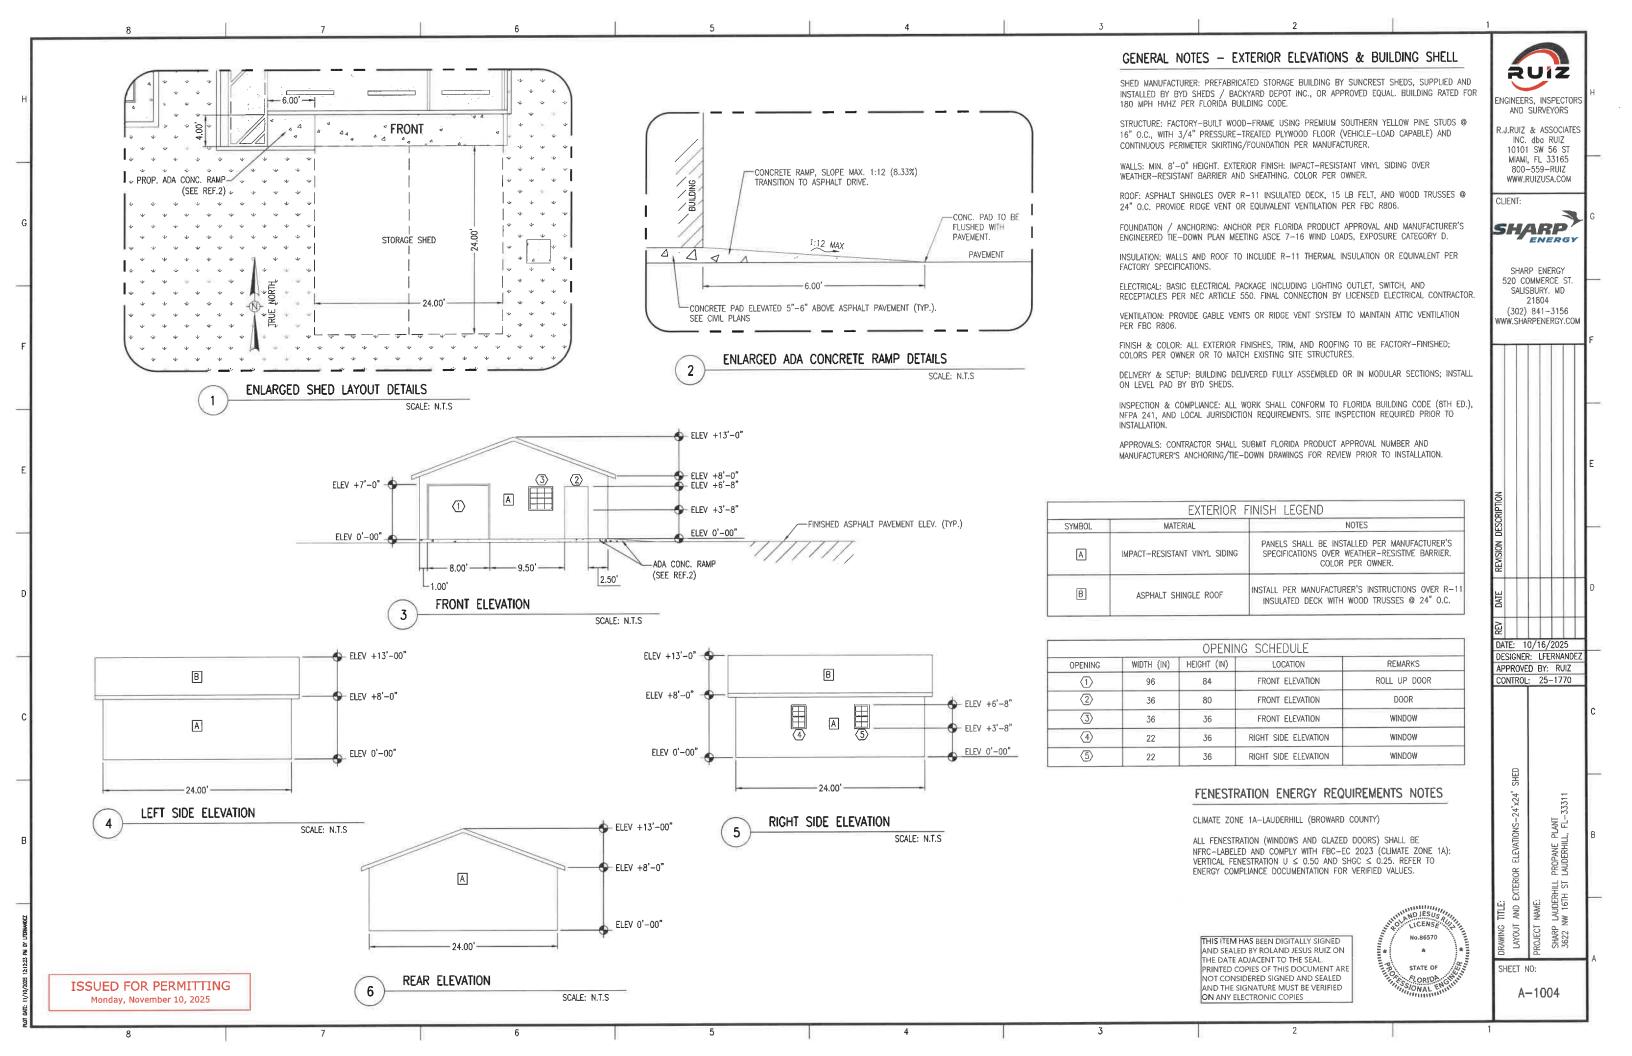

NOTES BROWARD COUNTY, FLORIDA LAT: 26° 8' 45.49" N - ELEVATIONS REFERENCE THE NORTH AMERICAN VERTICAL DATUM OF 1988 RUIZ LONG: 80° 11' 45.27" W COORDINATE SYSTEM: FLORIDA STATE PLANE EAST ZONE (FIPS 0901), NAD 83 (2011 ADJUSTMENT). BASIS OF NGINEERS, INSPECTORS BEARING PER RECORD PLAT/CONTROL POINTS AS SHOWN. AND SURVEYORS ALL WORK SHALL COMPLY WITH APPLICABLE CITY OF LAUDERHILL, BROWARD COUNTY, STATE AND FEDERAL CODES, SPECIFICATIONS, AND REQUIREMENTS. ALL REQUIRED LICENSES AND PERMITS SHALL BE OBTAINED AND PAID BY THE CONTRACTOR. WHERE DRAWINGS AND REGULATIONS CONFLICT, THE MOST STRINGENT REQUIREMENTS SHALL GOVERN. R.J.RUIZ & ASSOCIATES INC. dba RUIZ 10101 SW 56 ST MIAMI, FL 33165 - ALL TOPSOIL AND EXCAVATED MATERIALS SHALL BE STOCKPILED WITHIN THE LIMITS OF DISTURBANCE AS SHOWN 800-559-RHZ WWW.RUIZUSA.COM LOCATIONS OF EXISTING UNDERGROUND UTILITIES AND IMPROVEMENTS ARE APPROXIMATE, CONTRACTOR SHALL CLIENT FIELD-VERIFY PRIOR TO EXCAVATION AND PROTECT ALL UTILITIES. CALL SUNSHINE 811 (DIAL 811) A MINIMUM OF PROP. ASPHALT DRIVEWAY-48 HOURS BEFORE DIGGING. EXIST. ASPHALT APPROACH TO HEAVY DUTY SHARP EXIST. FIRE-**ASPHALT** DRIVEWAY MAINTAIN POSITIVE DRAINAGE AT ALL TIMES; PREVENT SATURATION OF EXPOSED SOILS DURING RAIN EVENTS. HYDRANT DRIVEWAY — EOP EXIST. CONTRACTOR'S MEANS, METHODS, SEQUENCING, TECHNIQUES, AND PROCEDURES ARE THE SOLE RESPONSIBILITY OF ASPHALT NW 16TH ST NW 16TH ST THE CONTRACTOR, INCLUDING COMPLIANCE WITH ALL HEALTH AND SAFETY REQUIREMENTS. DRIVEWAY 5(3) -- - -- - 5(D) - -- - - 5(D) - -- - - C/L SHARP ENERGY 520 COMMERCE ST. THE DESIGN ADEQUACY AND SAFETY OF ALL BRACING, SHORING, AND TEMPORARY SUPPORTS ARE THE SOLE MATCH EXISTING GRADE MATCH EXISTING GRADE-SALISBURY, MD RESPONSIBILITY OF THE CONTRACTOR. \_EOP 21804 GRASSED AREA MAXIMUM EMBANKMENT SLOPES SHALL BE 3:1 IN BOTH CUT AND FILL AREAS UNLESS NOTED OTHERWISE; MATCH (302) 841-3156  $- - \underline{w(\bar{y})} - - - \underline{-} \underline{w(D)} - \underline{RW} - \underline{DE} \underline{w(D)}$ WWW.SHARPENERGY.COM  $W(D) = -\frac{W(D)}{OE} - \frac{W(D)}{OE} - \frac{W(D)}{OE}$ EXIST. 4.8 CONC. SIDEWALK EXISTING TREES TO REMAIN AGGREGATE BASE (#57 STONE) AND GEOTEXTILE SHALL BE PROVIDED WHERE SHOWN ON DETAILS/PLANS; INLET STRUCTURE, S2-THICKNESSES AND EXTENTS PER PLAN CALLOUTS (NOT GENERIC). RIM ELEV.=6.10 6.36 PROP. 18" HDPE PIPE 6" CURB CONCRETE MATERIALS AND PLACEMENT SHALL CONFORM TO ACI 301/ACI 318; APPLY HOT/COLD WEATHER 6.49 -CE (1) E.INV. 4.10 PROP. 117LF OF 18" (TYP) CONCRETING PRACTICES PER ACI 305R/306R AS APPLICABLE. 6" CURB S.INV. 4.10 HDPE SOLID PIPE (TYP) CONCRETE SHALL ACHIEVE A MINIMUM COMPRESSIVE STRENGTH OF 3,000 PSI AT 28 DAYS UNLESS NOTED OTHERWISE; TESTING BY AN APPROVED MATERIALS LAB. INLET STRUCTURE, S1 RIM ELEV.=6.15 PROP 75 FT X 18" ø MAINTAIN REQUIRED CLEAR SIGHT TRIANGLES AND FIRE ACCESS; DO NOT PLACE FENCING, LANDSCAPING, OR PROP. 18" HDPE PIPE EXFILTRATION TRENCH INV. W. 4.15 PARKING WITHIN SIGHT TRIANGLES, SEE C-331 FOR FIRE LANE AND SIGHT TRIANGLE REQUIREMENTS. +6.55REV 6" BOLLARDS REF. 1 REF. 1) PERIMETER FENCE TYPICAL EXFILTRATION TRENCH NOTE A-1003 C-2002 & GATE DETAIL TYPICAL EXFILTRATION TRENCH: DESIGN/CONSTRUCTION SHALL COMPLY WITH SFWMD ERP APPLICANT'S HANDBOOK - VOLUME II (SOUTH FLORIDA DISTRICT) AND APPLICABLE CITY OF LAUDERHILL / BROWARD COUNTY ENGINEERING STANDARDS; PROVIDE GEOTEXTILE WRAP, CLEAN REF. 1 GRAVEL STONED WASHED STONE (VOID RATIO ≈ 0.40), INSPECTION/FLUSH PORTS, CONCRETE JUNCTION BOXES AT 6.69 C-2004 SURFACE DETAIL BENDS, MIN. SEPARATION TO SEASONAL HIGH GROUNDWATER, AND DRAIN-DOWN ≤ 72 HOURS; FINAL LAYOUT SUBJECT TO AHJ APPROVAL. REF. 5 EXFILTRATION TRENCH DETAIL C-2004 6.21'-REF. 2 HEAVY DUTY ASPHALT **LEGEND** INLET STRUCTURE, S3 DATE: 10/16/2025 C-2004 SURFACE DETAIL RIM ELEV.=6.15 DESIGNER: LFERNANDE PROP. 18" HOPE PIPE APPROVED BY: RUIZ PROP. FINAL GRADE ELEVATION POINT **♦**67.97 INV. N 4.10 CONTOUR LINE CONTROL: 25-1770 INV. E 4.10 Ш EXIST MAJOR PROP. DRAINAGE -1.84% CONTOUR LINE FLOW DIRECTION 6.75'-AND SLOPE EXIST MINOR TOP OF PAD PROP. 50 FT X 18" Ø-CONTOUR LINE 21 ELEV. 7.16' CONTROL POINT EXFILTRATION TRENCH 6.85 EXISTING GRADE F 67.62 ELEVATION POINT -0.18% -MATCH EXISTING GRADE (TYP) PROPERTY LINE CHAIN LINK FENCE DEPRESSED STORMWATER DETENTION AREA AND GRAVEL STONE AREAS (SEE REF. 1 ON SHEET C-2002) 크 EXISTING BUILDING PORTION TRACT "E" "INDUSTRIAL 100" P.B. 85, PG. 2, PARCEL ID: 494231240043 No.86570 THIS ITEM HAS BEEN DIGITALLY SIGNED AND SEALED BY ROLAND JESUS RUIZ ON THE DATE ADJACENT TO THE SEAL. STATE OF SHEET NO: PRINTED COPIES OF THIS DOCUMENT ARE NOT CONSIDERED SIGNED AND SEALED ISSUED FOR PERMITTING CIVIL PAVING, GRADING AND DRAINAGE PLAN AND THE SIGNATURE MUST BE VERIFIED C-2001 ON ANY ELECTRONIC COPIES Monday, November 10, 2025 SCALE: 1" = 20'-0", ANSI D

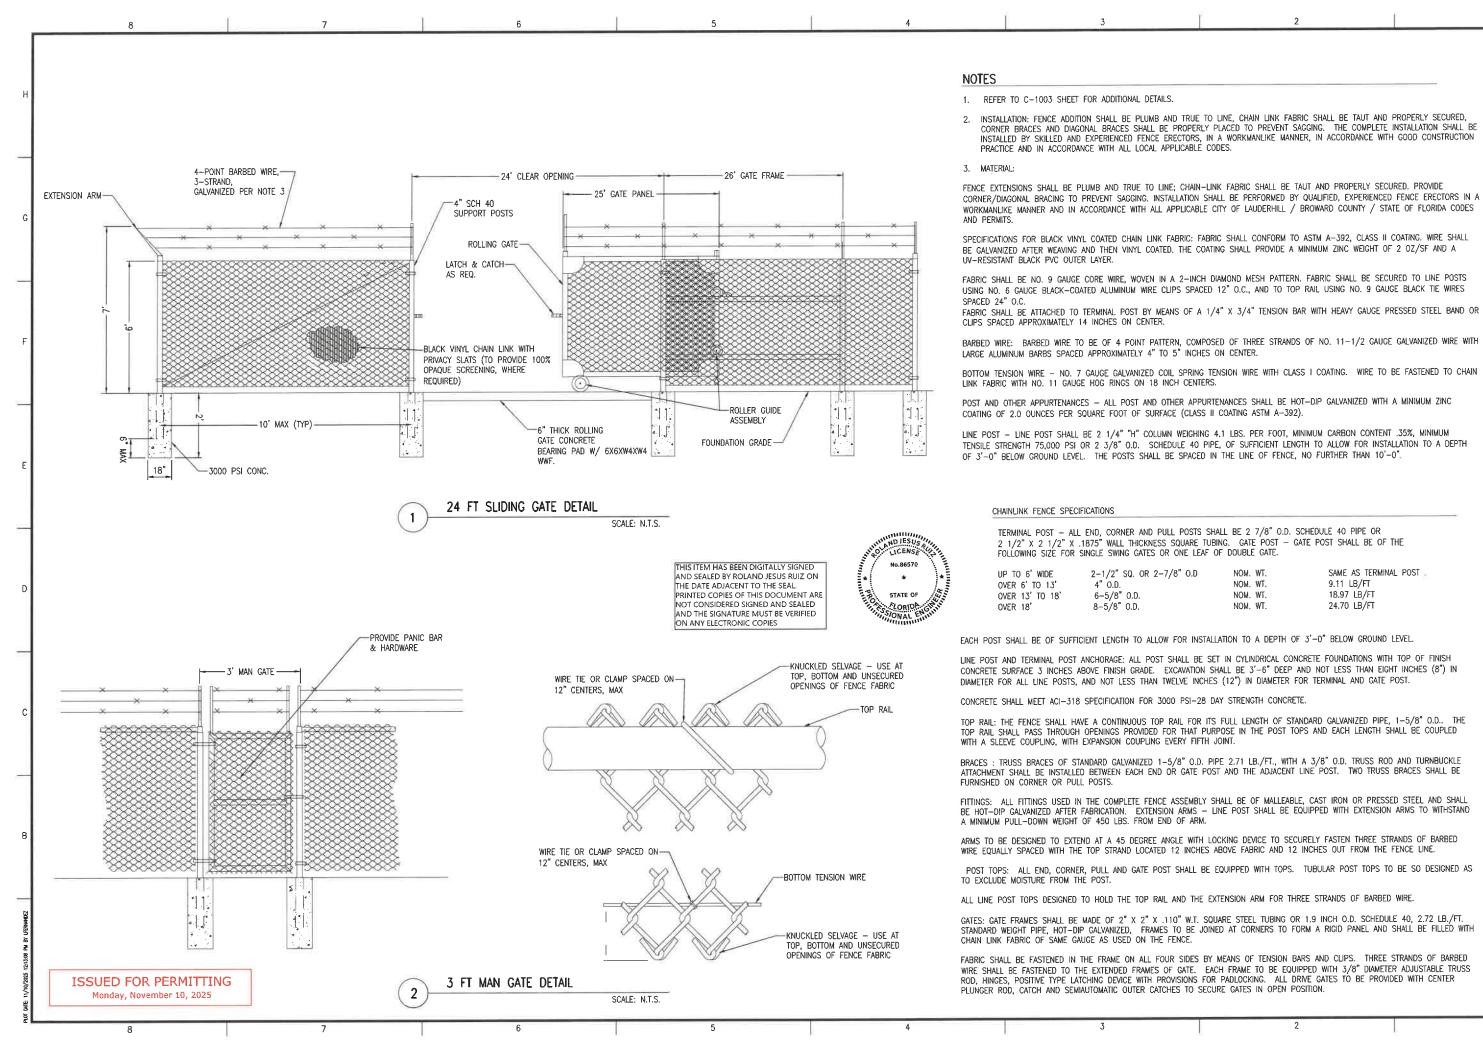

INGINEERS, INSPECTORS AND SURVEYORS

R.J.RUIZ & ASSOCIATE INC. dba RUIZ 10101 SW 56 ST MIAMI, FL 33165 800-559-RUIZ WWW.RUIZUSA.COM

CLIENT:



SHARP ENERGY 520 COMMERCE ST SALISBURY, MD 21804 (302) 841-3156

YWW.SHARPENERGY.COM


DESIGNER: LFERNANDE APPROVED BY: RUIZ


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RAWING FENCE SHARP 3622 SHEET NO:

DETAILS


C-2002



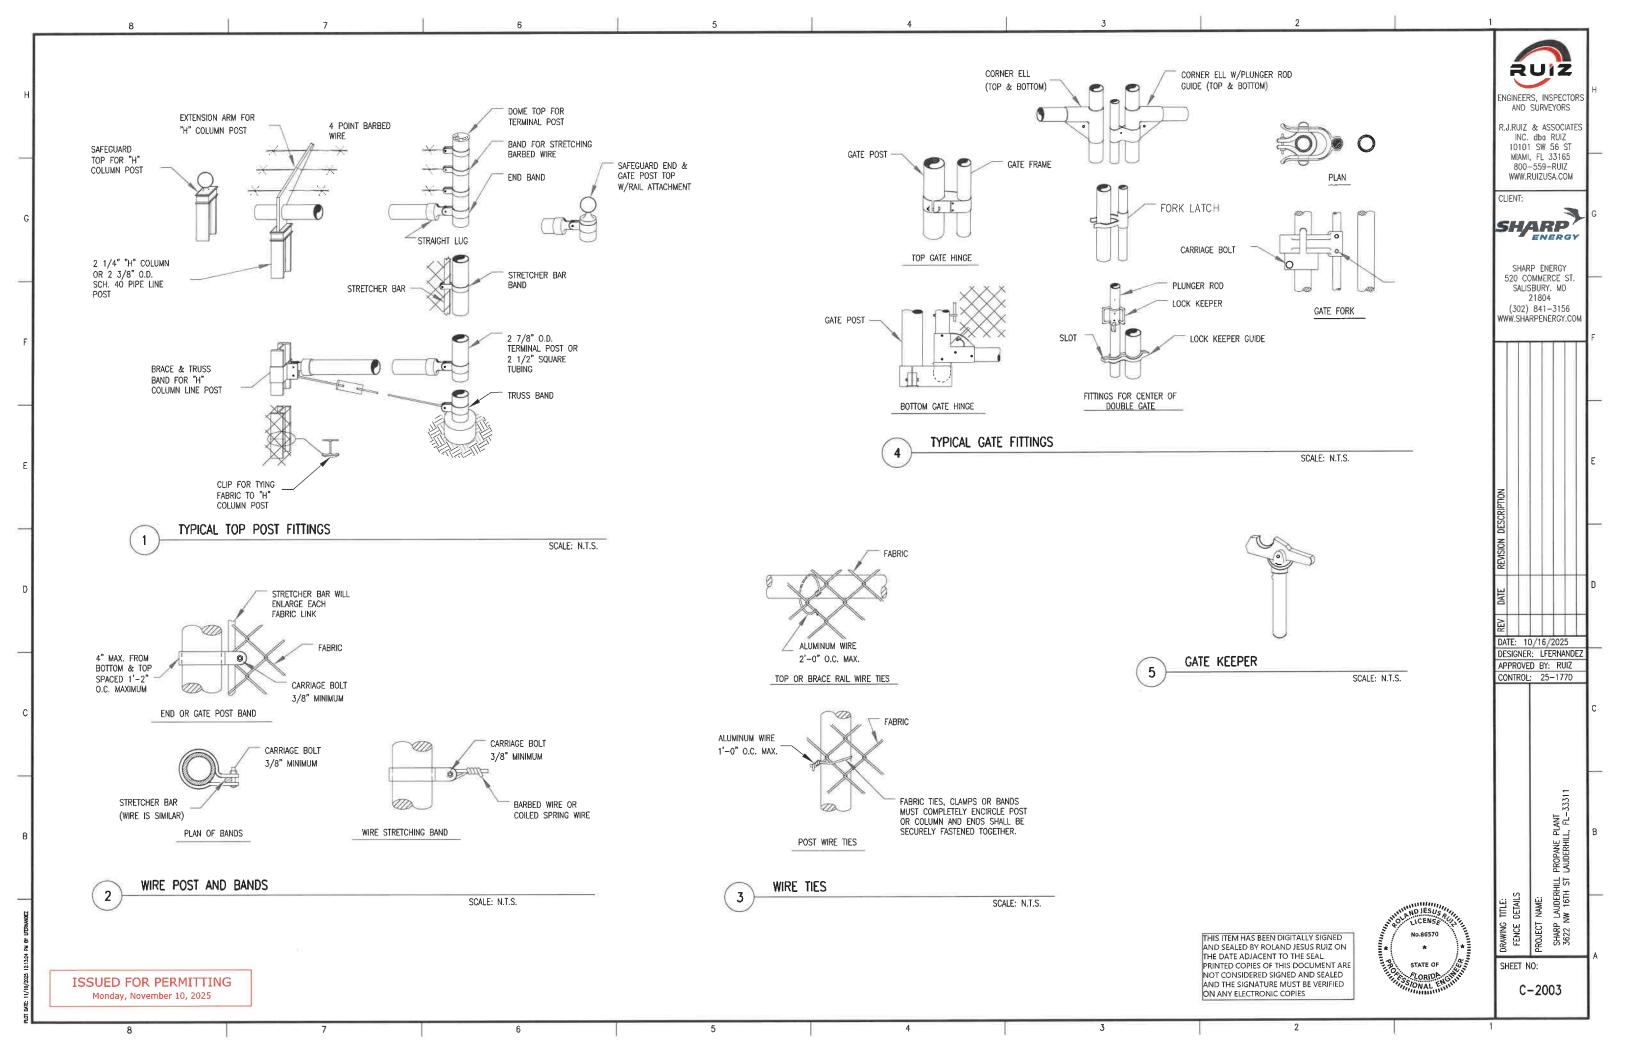

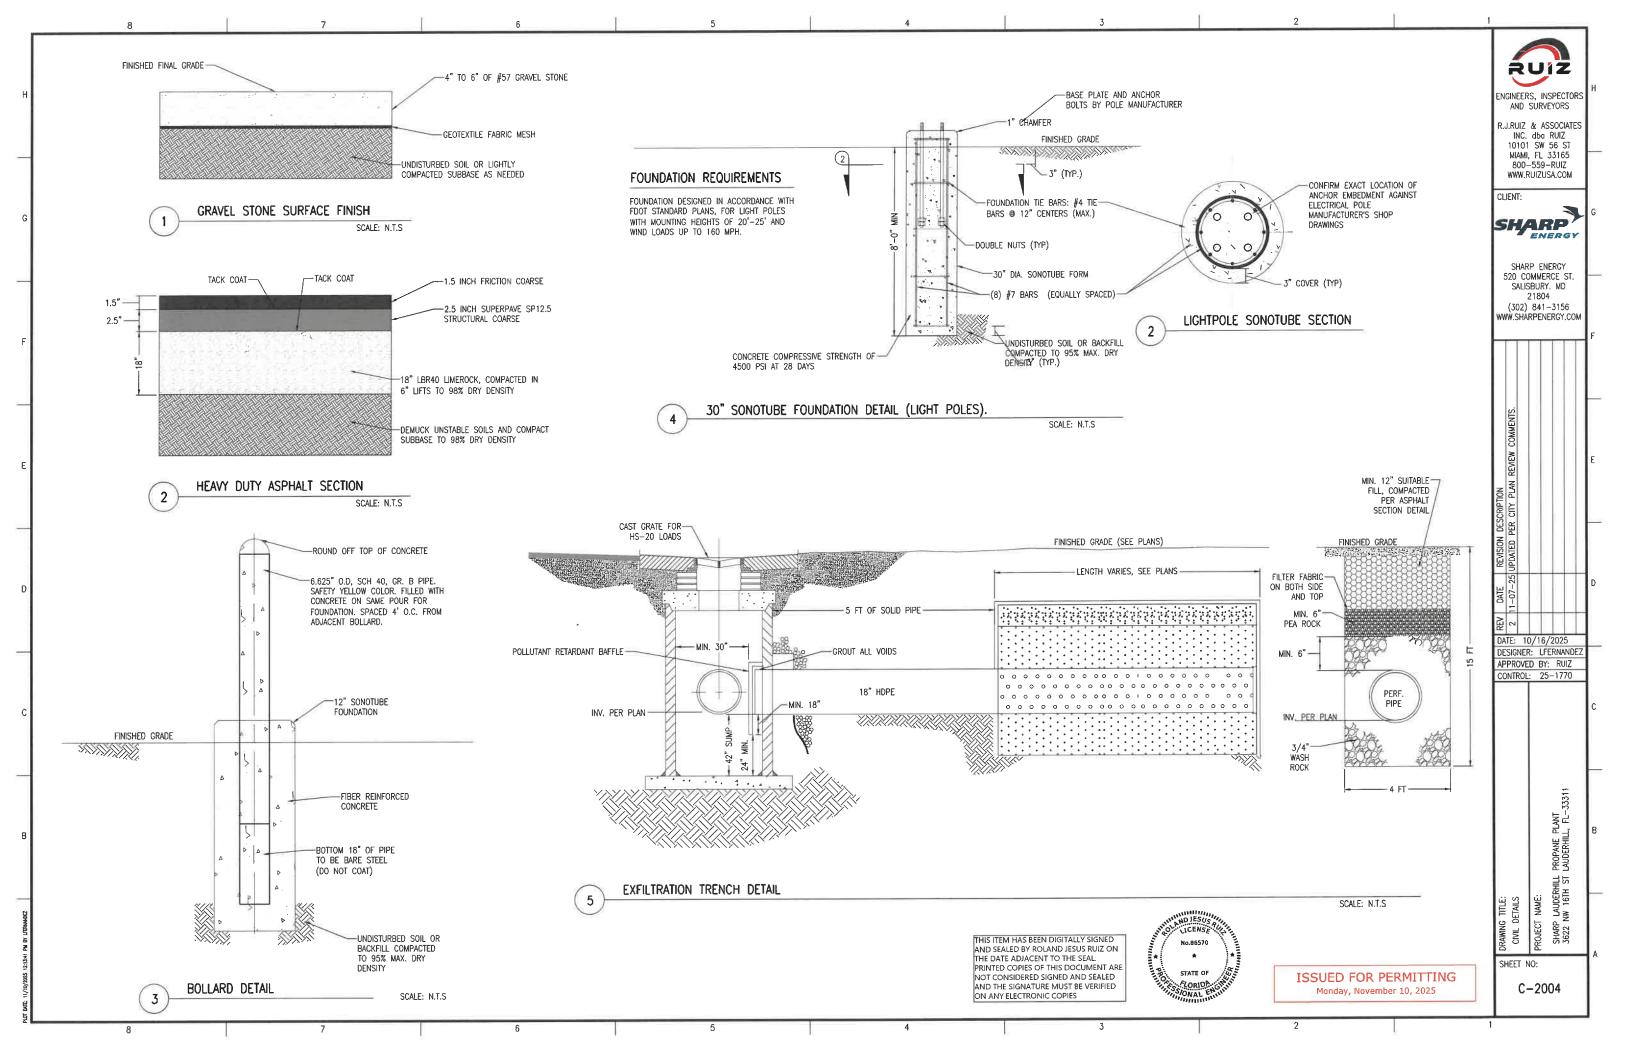KEY NOTES (WATER SERVICE) BROWARD COUNTY, FLORIDA LAT: 26° 8' 45.49" N RUIZ APPLICANT WILL OBTAIN POTABLE WATER CAPACITY ALLOCATION FROM THE CITY OF LAUDERHILL PRIOR LONG: 80' 11' 45.27" W TO DEVELOPMENT REVIEW COMMITTEE APPROVAL. NGINEERS INSPECTORS PROP. 6" PVC SANITARY SERVICE LATERAL FROM SHED TO PROPERTY LINE; INSTALL PER FLORIDA BUILDING CODE (PLUMBING) & AND SURVEYORS EXISTING BUILDING CITY OF LAUDERHILL UTILITIES STANDARD DETAILS. MAINTAIN UNIFORM MIN. SLOPE (>=1%) TOWARD CONNECTION POINT; BEDDING & "INDUSTRIAL 100" "INDUSTRIAL 100" BACKFILL PER UTILITY REQUIREMENTS (TYP.) R.J.RUIZ & ASSOCIATES PARCEL ID: 494231240036 PARCEL ID: 494231240038 INC. dba RUIZ 10101 SW 56 ST - PROP. 1" PVC SCH40 (OR PER UTILITY) FROM BACKFLOW TO BLDG; PROVIDE TRACER WIRE #12 AWG SOLID COPPER (BLUE) & MIAMI, FL 33165 TIE IN 6" LATERAL TO EXIST. GRAVITY SANITARY SEWER WITH WYE FITTING TO LAUDERHILL DETECTABLE WARNING TAPE 12" ABOVE PIPE (NON-METALLIC SERVICES). -PAVEMENT RESTORATION 800-559-RUIZ SPECIFICATIONS, CONTRACTOR TO VERIFY TIE-IN (SIZE/MATERIAL/RIM & INVERT) WITH CITY OF IN ACCORDANCE WITH WWW.RUIZUSA.COM MIN. COVER OVER WATER SERVICE: 36" TO FIN. GRADE (UNLESS UTILITY STATES OTHERWISE). LAUDERHILL LITHLITIES AND COORDINATE REQUIRED PERMITS AND FEES BEFORE CONNECTION. CITY STANDARDS HORIZONTAL SEPARATION TO SANITARY SEWER: >=10 FT (EDGE-TO-EDGE). IF <10 FT, WATER AT LEAST 18" ABOVE SEWER & PROP. 1" CORPORATION STOP: SLEEVE PER UTILITY STD (TYP.) AND TAP FOR 1" BRANCH EXIST. FIRE HYDRANT-SHARP VERTICAL CROSSING, WATER OVER SEWER: MIN. 18" CLEAR. IF SEPARATION CANNOT BE MAINTAINED, SLEEVE THE WATER LINE (PVC ENERGY - EOP SCH. 40 OR STEEL) A MIN. OF 5 FT BEYOND EACH SIDE OF THE CROSSING (TYP.). NW 16TH ST EXISTING SEWER-NW 16TH ST N 89' 13' 47" E 195.24' UNDER DRIVEWAYS/ENTRANCES: PROVIDE 2"PVC SCH. 40 SLEEVE (MIN.) FOR 1"SERVICE; EXTEND A MIN. OF 5 FT BEYOND PAVED ---s(b) ----s(b) -----s(b) -----s(c) -----s(c) SHARP ENERGY PROP. 1 EDGES (TYP.). -REMOVE AND RECONSTRUCT 520 COMMERCE ST. WATER METER SALISBURY. MD CONC. SIDEWALKS TO CITY EOP THRUST RESTRAINTS AT ELBOWS/TEES/PLUGS PER AWWA & UTILITY STANDARD; CONCRETE THRUST BLOCKS BEARING AGAINST 21804 STANDARDS EXIST. WATER MAIN-GRASSED AREA UNDISTURBED SOIL (TYP.). (302) 841-3156 WWW.SHARPENERGY.COM PROP. 1" ISOLATION GATE VALVE DOWNSTREAM OF BACKFLOW IN VALVE BOX FOR MAINTENANCE (OPTIONAL/RECOMMENDED). EXIST. 4.8' CONC. SIDEWALK - PROP. HOSE BIBB / FLUSH POINT AT INTERIOR END OF SERVICE FOR INITIAL FLUSHING & MAINTENANCE (TYP.). -PROP. 6" CLEANOUT (CO) - LABEL FLOW DIRECTION & TAGS: WM-TAP -> METER -> BFP -> SV-1 -> BLDG (TYP.). PROP. 1" BACKFLOW-PREVENTER PER UTILITY STD. - ALL MATERIALS & INSTALLATION PER UTILITY STANDARD, AWWA, FBC-P, AND CITY OF LAUDERHILL DETAILS (TYP.). -PROP. 6" PVC SANIT, LATERAL -MAINTAIN UNIFORM MIN. PROP. 1" PVC SCH40 PRESSURE TEST, FLUSH, AND DISINFECTION PER AWWA C651; TWO CONSECUTIVE ACCEPTABLE BACTERIOLOGICAL SAMPLES REQUIRED SLOPE=1.00% (TYP.). WATER SERVICE PRIOR TO SERVICE (TYP.). - COORDINATE METER SIZE/TYPE & BACKFLOW TYPE WITH UTILITY; SUBMIT CUTSHEETS FOR APPROVAL PRIOR TO INSTALLATION. - RESTORE PAVEMENT, SOD, AND IRRIGATION IN DISTURBED AREAS TO EQUAL OR BETTER CONDITION (TYP.). - CALL SUNSHINE 811 (CALL BEFORE YOU DIG) >= 3 BUSINESS DAYS PRIOR TO EXCAVATION; FIELD-VERIFY ALL UTILITIES. 100 KEY NOTES (SEWER) - PROP. 6" PVC SANITARY SERVICE LATERAL FROM SHED TO PROPERTY LINE; INSTALL PER FLORIDA BUILDING CODE (PLUMBING) & CITY OF LAUDERHILL UTILITIES STANDARD DETAILS. MAINTAIN UNIFORM MIN. SLOPE (>=1%) TOWARD CONNECTION POINT; BEDDING TRACT PG. & BACKFILL PER UTILITY REQUIREMENTS (TYP.) FREESTANDING-- PROP. CLEANOUT (CO) AT PROPERTY LINE IN BOX W/ LID MARKED "SEWER"; LID FLUSH W/ GRADE; INSTALL PER CITY UTILITIES STD. (TYP.). - PROP. INTERMEDIATE CLEANOUTS AT CHANGES IN DIRECTION AND PER UTILITY SPACING REQUIREMENTS (TYP.). REFER TO FUTURE BEDDING: COMPACTED GRANULAR MATERIAL; BACKFILL & DENSITY PER UTILITY SPEC; RESTORE ROW/PAVEMENT PER CITY PERMITTING DESIGNER: LEERNANDI STANDARD DETAILS (TYP.). PLUMBING PLANS APPROVED BY: RUIZ FOR FINAL - TESTING: LOW-PRESSURE AIR & DEFLECTION (MANDREL) AS REQUIRED; CCTV PRE/POST IF REQUIRED BY UTILITY. ONTROL: 25-1770 **TERMINATIONS** CONTRACTOR TO COORDINATE CUT-IN/INSPECTION W/ CITY >=72 HRS PRIOR; PROVIDE BYPASS/DEWATERING; MAINTAIN SERVICE -HOSE BIR AT STORAGE SHED WALL RIM/INVERT ELEVATIONS AND SEGMENT SLOPES TO BE PROVIDED WITH THE ENGINEERING PERMIT SUBMITTAL; CONSTRUCTION SHED LEGEND DETAILS AND SPECIFICATIONS WILL BE HANDLED IN THAT PHASE. CONTRACTOR SHALL FIELD-VERIFY EXISTING INVERTS/RIMS 24'x24' PRIOR TO CUT-IN (TYP.). - PROPERTY LINE EASEMENT PERMITTING LINE (EXIST.) SANITARY SEWER CAPACITY & OFF-SITE IMPACTS EASEMENT PERMITTING LINE (PROP.) APPLICANT WILL OBTAIN SANITARY SEWER CAPACITY ALLOCATION FROM THE CITY OF LAUDERHILL PRIOR TO DEVELOPMENT 6 6 6 6 6 6 6 6 6 6 6 6 REVIEW COMMITTEE APPROVAL. EXIST. 8" SDR 21 PVC WATER MAIN - FOR CAPACITY ALLOCATION, ASSUME MINIMUM WASTEWATER CAPACITY OF 1 ERU = 200 GPD (BROWARD WWS BASIS), UNLESS OTHERWISE DIRECTED BY THE CITY OF LAUDERHILL. EXISTING BURIED COPPER TELEPHONE LINE - THIS DEVELOPMENT HAS VERY LOW DOMESTIC SEWER DEMAND; MINIMUM CAPACITY IS REQUESTED BASED ON ONE TOILET AND ⊒ા EXISTING BUILDING ONE LAVATORY (ASSUMPTION: THREE PERSONS; EST. AVG. FLOW & 50 GPD). PORTION TRACT "E" "INDUSTRIAL 100" -- OE- -- EXIST. OVERHEAD ELECT. - - OE- -P.B. 85, PG. 2, PARCEL ID: 494231240043 - APPLICANT WILL COORDINATE WITH CITY OF LAUDERHILL UTILITIES TO EVALUATE POTENTIAL OFF-SITE SANITARY SEWER IMPACTS EXIST. ELECTRICAL BURIED AND ANY APPLICABLE FEES, AND WILL PROVIDE CITY CONFIRMATION WITH PERMIT SUBMITTAL. CHAIN LINK FENCE LICENSE LANDSCAPE IRRIGATION WILL BE PROVIDED BY AN ON-SITE WELL, NOT CONNECTED TO PUBLIC POTABLE WATER (WELL THIS ITEM HAS BEEN DIGITALLY SIGNED LOCATION TO BE CONFIRMED DURING PERMITTING) SANITARY SEWER LINE AND SEALED BY ROLAND JESUS RUIZ ON No.86570 THE DATE ADJACENT TO THE SEAL. SHEET NO: PRINTED COPIES OF THIS DOCUMENT ARE NOT CONSIDERED SIGNED AND SEALED ISSUED FOR PERMITTING STATE OF WATER & SEWER PLAN LORIDA SIONAL C-3001 AND THE SIGNATURE MUST BE VERIFIED Monday, November 10, 2025 ON ANY FLECTRONIC COPIES SCALE: 1" = 20'-0", ANSI D

EROSION AND SEDIMENT CONTROL NOTES BROWARD COUNTY, FLORIDA LAT: 26° 8' 45.49" N LONG: 80° 11' 45.27" W REFER\_TO\_SHEET C-4002 FOR ADDITIONAL REQUIREMENTS RELATED TO EROSION AND SEDIMENT CONTROL PLAN NGINEERS, INSPECTORS AND SURVEYORS THE BEST MANAGEMENT PRACTICES (BMPs) SHALL BE INSTALLED IN SUCH WAY TO EXISTING BUILDING EXISTING BUILDING PREVENT LOSS OF SOIL DURING CONSTRUCTION BY STORMWATER RUNOFF AND/OR "INDUSTRIAL 100" "INDUSTRIAL 100" R.J.RUIZ & ASSOCIATES WIND EROSION, INCLUDING PROTECTING TOPSOIL BY STOCKPILING FOR REUSE. ALL PARCEL ID: 494231240036 PARCEL ID: 494231240038 INC. dba RUIZ 10101 SW 56 ST BMPs SHALL PROVIDE SEDIMENTATION PROTECTION OF STORM SEWER OR RECEIVING STREAM; AND SHALL PREVENT POLLUTING THE AIR WITH DUST AND PARTICULATE MIAMI, FL 33165 800-559-RUIZ LOD COVERS UTILTY CONNECTIONS-WWW.RUIZUSA.COM CONTRACTOR SHALL IMPLEMENT BMPs IN ALL CONSTRUCTION ACTIVITIES INCLUDING BUT AND ROAD RESTORATION NOT LIMITED TO: FUEL SPILLS AND LEAKS PREVENTION, VEHICLE AND EQUIPMENT CLIENT: WASHING AND STEAM CLEANING, VEHICLE AND EQUIPMENT MAINTENANCE AND REPAIR, AVOID MUD TRACKING ONTO-OUTDOOR LOADING/UNLOADING OF MATERIALS, OUTDOOR STORAGE OF RAW MATERIALS, HIGHWAY. PROVIDE TRUCK PROVIDE TEMPORARY ACCESS SHARP PRODUCTS, AND BY-PRODUCTS, SOLID WASTE MANAGEMENT, HAZARDOUS WASTE TIRE WASH AREA AS NEEDED SECURITY GATES AS NEEDED MANAGEMENT, CONCRETE WASTE MANAGEMENT, SANDBLASTING WASTE MANAGEMENT, STRUCTURE CONSTRUCTION AND PAINTING, SPILL PREVENTION AND CONTROL, NW 16TH ST CONTAMINATED SOIL MANAGEMENT, SANITARY /SEPTIC WASTE MANAGEMENT, SOIL NW 16TH ST N 89° 13' 47" E 195.24' EROSION CONTROL, AND STORM WATER TURBIDITY MANAGEMENT. SHARP ENERGY 520 COMMERCE ST. == C/L <del>}=</del> - == - <del>S(D) - - - -</del> - - - - S(D) - - - - S(D) - - - -S(D) = - - - S(D) = - - - S(D)CONTRACTOR SHALL MINIMIZE CLEARING TO THE MAXIMUM EXTENT PRACTICAL CLEARING WILL BE LIMITED TO THE AREAS DEFINED BY PERPETUAL AND TEMPORARY SALISBURY. MD EOP 21804 CONSTRUCTION EASEMENT LIMITS. GRASSED AREA (302) 841-3156 (1) DE \_\_\_\_\_ OE W(D) \_\_\_ RW \_OE W(D) \_ 
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 QE \_\_\_\_\_W(D) \_\_\_\_\_OF\_W(D) WWW.SHARPENERGY.CO CONTRACTOR SHALL BEGIN CLEARING AND GRUBBING THOSE PORTIONS OF THE SITE NECESSARY TO IMPLEMENT PERIMETER CONTROL MEASURES. CLEARING AND GRUBBING FOR THE REMAINING PORTIONS OF THE PROPOSED SITE SHALL COMMENCE ONCE PERIMETER CONTROLS ARE IN PLACE, PERIMETER CONTROLS SHALL BE ACTIVELY MAINTAINED UNTIL SAID AREAS HAVE BEEN STABILIZED AND SHALL BE REMOVED ONCE FINAL STABILIZATION IS COMPLETE. REF. 4 PERIMETER SILT GENERAL EROSION CONTROL BMPS SHALL BE EMPLOYED TO MINIMIZE SOIL EROSION. C-4002 FENCE DETAIL WHILE THE VARIOUS TECHNIQUES REQUIRED WILL BE SITE AND PLAN SPECIFIC, THEY SHOULD BE EMPLOYED AS SOON AS POSSIBLE DURING CONSTRUCTION. ON-SITE SOIL STOCKPILE AND BORROW AREAS SHALL BE PROTECTED FROM EROSION AND SEDIMENTATION THROUGH IMPLEMENTATION OF BMPs. PROVIDE 20FT WIDE X 80FT LONG STONED CONSTRUCTION ENTRANCE OVER FILTER FABRIC IN ACCORDANCE WITH FLORIDA DEP SPECS 100, 20.00 ISTRIAL 1 ID: 494 PROPOSED CONSTRUCTION, TEMPORARY-TRACT PG. 2 PARKING, MATERIAL STAGING, AND LIMITS OF DISTURBANCE AREAS DRTION 1 P.B. 85, TOTAL = 37948 SF (.87 AC)10. 47, **LEGEND** Ö DATE: 10/17/2025 오 DESIGNER: LFERNANDE PERIMETER SILT FENCING IN ACCORDANCE WITH DETAILS APPROVED BY: RUIZ CONTROL: 25-1770 LOD LIMITS OF DISTURBANCE PROPANE LAUDERHIL JOERHILL 16TH ST PORTION TRACT "E" "INDUSTRIAL 100" P.B. 85, PG. 2, PARCEL ID: 494231240043 SHARP 3622 I THIS ITEM HAS BEEN DIGITALLY SIGNED AND SEALED BY ROLAND JESUS BUIZ ON THE DATE ADJACENT TO THE SEAL. SHEET NO: PRINTED COPIES OF THIS DOCUMENT ARE STATE OF NOT CONSIDERED SIGNED AND SEALED EROSION AND SEDIMENT CONTROL PLAN **ISSUED FOR PERMITTING** AND THE SIGNATURE MUST BE VERIFIED C-4001 ON ANY ELECTRONIC COPIES Monday, November 10, 2025 SCALE: 1'' = 20' - 0'', ANSI D

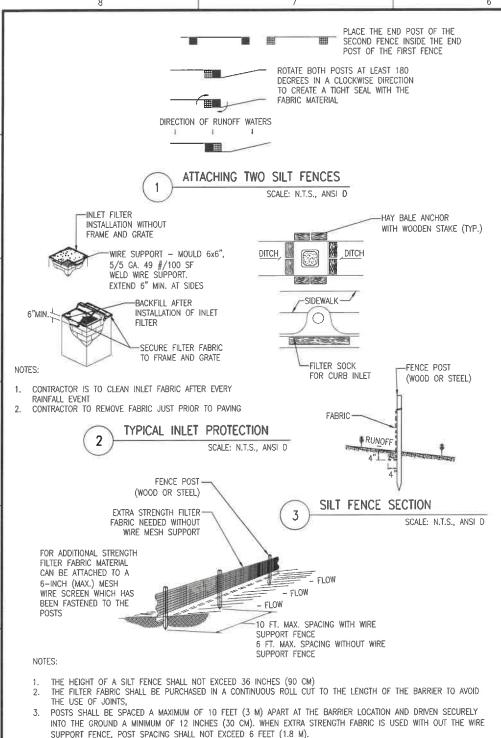

4. A TRENCH SHALL BE EXCAVATED APPROXIMATELY 4 INCHES (10 CM) WIDE AND 4 INCHES (10 CM) DEEP ALONG THE LINE OF POSTS AND UPSLOPE FROM THE BARRIER

WHEN STANDARD STRENGTH FILTER FABRIC IS USED, A WIRE MESH SUPPORT FENCE SHALL BE FASTENED SECURELY TO THE UPSLOPE SIDE OF THE POSTS USING HEAVY DUTY WIRE STAPLES AT LEAST 1 INCH (25 MM) LONG, TIE WIRES, OR HOG RINGS. THE WIRE SHALL EXTEND INTO THE TRENCH A MINIMUM OF 2 INCHES (5 CM) AND SHALL NOT EXTEND MORE THAN 36 INCHES (90 CM) ABOVE THE ORIGINAL GROUND SURFACE.

THE STANDARD STRENGTH FILTER FABRIC SHALL BE STAPLED OR WIRED TO THE FENCE, AND 8 INCHES (20 CM) OF FABRIC SHALL BE EXTENDED INTO THE TRENCH. THE FABRIC SHALL NOT EXTEND MORE THAN 36 INCHES (90 CM)

7. THE TRENCH SHALL BE BACKFILLED AND THE SOIL COMPACTED OVER THE FILTER FABRIC.



THIS ITEM HAS BEEN DIGITALLY SIGNED AND SEALED BY ROLAND JESUS RUIZ ON THE DATE ADJACENT TO THE SEAL. PRINTED COPIES OF THIS DOCUMENT ARE NOT CONSIDERED SIGNED AND SEALED. AND THE SIGNATURE MUST BE VERIFIED ON ANY ELECTRONIC COPIES

# STORM WATER EROSION CONTROL PRACTICES

CONTRACTORS OR SUBCONTRACTORS WILL BE RESPONSIBLE FOR REMOVING SEDIMENT FROM DETENTION PONDS AND AN' SEDIMENT THAT MAY HAVE COLLECTED IN THE STORM SEWER DRAINAGE SYSTEMS IN CONJUNCTION WITH THE STABILIZATION OF THE SITE

SLOPES SHALL BE LEFT IN A ROUGHENED CONDITION DURING THE GRADING PHASE TO REDUCE RUNOFF VELOCITIES AND

DUE TO THE GRADE CHANGES DURING THE DEVELOPMENT OF THE PROJECT, THE CONTRACTOR SHALL BE RESPONSIBLE FOR ADJUSTING THE FROSION CONTROL MEASURES (COMPOST SOCK DEVICES, ETC.) TO PREVENT EROSION.

WHERE PRACTICAL, STORM WATER SHALL BE CONVEYED BY SWALES.

EROSION CONTROL MEASURES SHALL BE EMPLOYED TO MINIMIZE TURBIDITY OF SURFACE WATERS LOCATED DOWNSTREAM OF ANY CONSTRUCTION ACTIVITY WHILE THE VARIOUS MEASURES REQUIRED WILL BE SITE SPECIFIC. THEY SHALL BE EMPLOYED AS NEEDED IN ACCORDANCE WITH THE

5.1. IN GENERAL, EROSION SHALL BE CONTROLLED AT THE FURTHEST PRACTICAL LIPSTREAM LOCATION

STORMWATER INLETS SHALL BE PROTECTED DURING CONSTRUCTION, PROTECTION MEASURES SHALL BE EMPLOYED AS SOON AS PRACTICAL DURING THE VARIOUS STAGES OF INLET CONSTRUCTION, SILT BARRIERS SHALL REMAIN IN PLACE UNTIL SODDING AROUND INLETS IS COMPLETE.

WHEN NEEDED, A TEMPORARY SEDIMENT TRAP SHOULD BE CONSTRUCTED TO DETAIN SEDIMENT-LADEN RUNOFF FROM DISTURBED AREAS.

SILT BARRIERS, ANY SILT WHICH ACCUMULATES BEHIND THE BARRIERS, AND ANY FILL USED TO ANCHOR THE BARRIERS SHALL BE REMOVED PROMPTLY AFTER THE END OF THE MAINTENANCE PERIOD SPECIFIED FOR THE BARRIERS.

SLOPES OF BANKS OF RETENTION/ DETENTION PONDS SHALL BE CONSTRUCTED NOT STEEPER THAN 3H:1V FROM TOP OF BANK TO TWO FEET BELOW NORMAL WATER LEVEL. AS APPLICABLE.

SOD SHALL BE PLACED FOR A 2-FOOT WIDE STRIP ADJOINING ALL CURBING AND AROUND ALL INLETS. SOD SHALL BE PLACED BEFORE SILT BARRIERS ARE REMOVED

WHERE REQUIRED TO PREVENT EROSION FROM SHEET FLOW ACROSS BARE GROUND FROM ENTERING A LAKE OR SWALE, A TEMPORARY SEDIMENT SUMP SHALL BE CONSTRUCTED FILTER FABRIC SHOULD BE USED FOR STORM DRAIN INLET

### PROTECTION BEFORE FINAL STABILIZATION WIND EROSION CONTROL PRACTICES

WIND EROSION SHALL BE CONTROLLED BY EMPLOYING THE FOLLOWING METHODS AS NECESSARY AND APPROPRIATE:

BARE FARTH AREAS SHALL BE WATERED DURING CONSTRUCTION AS NECESSARY TO MINIMIZE THE TRANSPORT OF FUGITIVE DUST IT MAY BE NECESSARY TO LIMIT CONSTRUCTION VEHICLE SPEED IF BARE EARTH HAS NOT BEEN EFFECTIVELY WATERED. IN NO CASE SHALL FUGITIVE DUST BE ALLOWED TO LEAVE THE SITE LINDER CONSTRUCTION

DISTURBED PORTIONS OF THE SITE WHERE CONSTRUCTION ACTIVITY HAS PERMANENTLY STOPPED SHALL BE PERMANENTLY SEEDED. THESE AREAS SHALL BE SEEDED NO LATER THAN 14 DAYS AFTER THE LAST CONSTRUCTION ACTIVITY OCCURRING IN THESE AREAS. CLEARED SITE DEVELOPMENT AREAS NOT CONTINUALLY SCHEDULED FOR CONSTRUCTION ACTIVITIES SHALL BE COVERED WITH HAY OR OVERSEEDED AND PERIODICALLY WATERED SUFFICIENTLY TO STABILIZE THE TEMPORARY GROUNDCOVER

AT ANY TIME BOTH DURING AND AFTER SITE CONSTRUCTION THAT WATERING AND/OR VEGETATION ARE NOT FEFECTIVE IN CONTROLLING WIND FROSION AND/OR TRANSPORT OF FUGITIVE DUST, OTHER METHODS AS ARE NECESSARY FOR SUCH CONTROL SHALL BE EMPLOYED. THESE METHODS SHOULD INCLUDE ERECTION OF DUST CONTROL FENCES. A 6-FT GEOTEXTILE FILTER FIBER SHOULD BE HANGING AGAINST THE CHAIN LINK PERIMETER FENCE AND GATE

ALL DUST ON THE SITE SHALL BE CONTROLLED, THE USE OF MOTOR OILS AND OTHER PETROLEUM BASED OR TOXIC LIQUIDS FOR DUST SUPPRESSION OPERATIONS IS PROHIBITED



# WASTE DISPOSAL

WASTE MATERIALS - ALL WASTE MATERIALS SHALL BE COLLECTED AND STORED IN A METAL DUMPSTER WITH A SECURE LID IN ACCORDANCE WITH ALL LOCAL AND STATE LAWS, ALL TRASH AND CONSTRUCTION DEBRIS FROM THE SITE SHALL BE DEPOSITED IN THE DUMPSTER. THE SUPERINTENDENT SHALL COORDINATE WITH THE LOCAL UTILITIES TO HAVE THE DUMPSTER EMPTIED AT LEAST TWICE A WEEK AND THE WASTE TAKEN TO AN APPROPRIATE LANDFILL. NO CONSTRUCTION WASTE MATERIALS SHALL BE BURIED ON SITE. THE SUPERINTENDENT SHALL ORGANIZE TRAINING FOR THE EMPLOYEES IN THE PROPER PRACTICES WHEN DEALING WASTE MATERIALS. THE SUPERINTENDENT SHALL BE RESPONSIBLE FOR POSTING AND ENFORCING WASTE MATERIAL PROCEDURES

HAZARDOUS WASTE - HAZARDOUS WASTE MATERIALS SHALL BE DISPOSED OF IN ACCORDANCE WITH ALL LOCAL AND STATE LAWS OR AS DIRECTED BY THE MANUFACTURER. THE SUPERINTENDENT SHALL ORGANIZE THE PROPER TRAINING FOR EMPLOYEES IN THE PROPER PRACTICES WHEN DEALING WITH HAZARDOUS WASTE MATERIALS. THESE PROCEDURES SHALL BE POSTED ON THE SITE. THE PERSON WHO MANAGES THE SITE SHALL BE RESPONSIBLE FOR ENFORCING THE PROCEDURES

SANITARY WASTE - SANITARY WASTE SHALL BE COLLECTED AND DISPOSED OF IN ACCORDANCE WITH ALL LOCAL AND STATE LAWS. THE SUPERINTENDENT SHALL COORDINATE WITH THE LOCAL UTILITY FOR COLLECTION OF THE SANITARY WASTE AT LEAST THREE TIMES A WEEK TO PREVENT SPILLAGE ONTO THE SITE

RUBBISH, TRASH, GARBAGE, UTTER, OR OTHER SUCH MATERIALS SHALL BE DEPOSITED INTO SEALED CONTAINERS, MATERIALS SHALL BE PREVENTED FROM LEAVING THE PREMISES THROUGH THE ACTION OF WIND OR STORM WATER DISCHARGE INTO DRAINAGE DITCHES OR WATERS OF THE STATE.

# OFF-SITE TRACKING

STABILIZED CONSTRUCTION ENTRANCE SHALL BE PROVIDED TO REDUCE SEDIMENT TRACKING DEFSITE. THE MAJOR ROAD CONNECTED TO THE PROJECT SHALL BE CLEANED ONCE A DAY TO REMOVE ANY EXCESS MUD. DIRT OR ROCK RESULTING FROM CONSTRUCTION TRAFFIC. ALI TRUCKS HAULING MATERIALS OFFSITE SHALL BE COVERED WITH A TARPAULIN.

GENERAL CONTRACTOR SHALL DENOTE ON PLAN THE TEMPORARY PARKING AND STORAGE AREA WHICH SHALL ALSO BE USED AS THE EQUIPMENT MAINTANCE AND CLEANING AREA EMPLOYEE PARKING AREA, AND AREA FOR LOCATION PORTABLE FACILITIES, OFFICE TRAILERS, AND TOILET FACILITIES. HEAVY CONSTRUCTION EQUIPMENT PARKING AND MAINTENANCE AREAS SHALL BE DESIGNED TO PREVENT OIL GREASE AND LUBRICANTS FROM ENTERING SITE DRAINAGE FEATURES INCLUDING STORMWATER COLLECTION AND TREATMENT SYSTEMS, CONTRACTORS SHALL PROVIDE BROAD DIKES. HAY BALES OR SILT SCREENS AROUND, AND SEDIMENT SUMPS WITHIN SUCH AREAS AS REQUIRED TO CONTAIN SPILLS OF OIL, GREASE OR LUBRICANTS, CONTRACTORS SHALL HAVE AVAILABLE, AND SHALL USE, ABSORBENT FILTER PADS TO CLEAN UP SPILLS

AS SOON AS POSSIBLE AFTER OCCURRENCE. ALL WASH WATER FROM CONCRETE TRUCKS. VEHICLE CLEANING, EQUIPMENT CLEANING, ETC. SHALL BE DETAINED ON SITE AND SHALL BE PROPERLY TREATED OR DISPOSED

IF THE ACTION OF VEHICLES TRAVELING OVER THE GRAVEL CONSTRUCTION ENTRANCES IS NOT SUFFICIENT TO REMOVE THE MAJORITY OF DIRT OR MUD THEN THE TIRES MUST BE WASHED REFORE THE VEHICLES ENTER A PUBLIC ROAD, IF WASHING IS USED, PROVISIONS MUST BE MADE TO INTERCEPT THE WASH WATER AND TRAP THE SEDIMENT BEFORE IT IS CARRIED OFF THE SITE.

ALL MATERIALS SPILLED, DROPPED, WASHED, DR TRACKED FROM VEHICLES ONTO ROADWAYS OR INTO STORM DRAINS MUST BE REMOVED

# MAINTENANCE

1. ALL MEASURES STATED ON THIS EROSION AND SEDIMENT CONTROL PLAN, AND IN THE STORM WATER POLITITION PREVENTION PLAN. SHALL BE MAINTAINED IN FULL Y FUNCTIONAL CONDITION UNTIL NO LONGER REQUIRED FOR A COMPLETED PHASE OF WORK OR FINAL STABILIZATION OF THE SITE

ALL MEASURES STATED ON THIS EROSION AND SEDIMENT CONTROL PLAN. AND IN THE STORM WATER POLLUTION PREVENTION PLAN, SHALL BE MAINTAINED IN FULL Y FUNCTIONAL CONDITION LINTH NO LONGER REQUIRED FOR A COMPLETED PHASE OF WORK OR FINAL STABILIZATION OF THE SITE

ALL EROSION AND SEDIMENTATION CONTROL MEASURES SHALL BE CHECKED BY A QUALIFIED PERSON AT LEAST ONCE EVERY SEVEN CALENDAR DAYS AND WITHIN 24 HOURS OF THE END OF A 0.5" RAINFALL EVENT, AND CLEANED AND REPAIRED IN ACCORDANCE "WITH THE FOLLOWING:

3.1. INLET PROTECTION DEVICES AND BARRIERS SHALL BE REPAIRED OR REPLACED IF THEY SHOW SIGNS OF UNDERMINING, OR DETERIORATION.

ALL SEEDED AREAS SHALL BE CHECKED 3.2. REGULARLY TO SEE THAT A GOOD STAND IS MAINTAINED, AREAS SHOULD BE FERTILIZED, WATERED, AND RESEEDED AS NEEDED.

THE COMPOST SOCK FILTRATION DEVICE SHALL BE INSPECTED PERIODICALLY FOR HEIGHT OF SEDIMENT AND CONDITION OF DEVICE, COMPOST SOCK SHALL BE REPAIRED TO ITS ORIGINAL CONDITIONS IF DAMAGED. SEDIMENT SHALL BE REMOVED FROM THE COMPOST SOCK WHEN IT REACHES ONE-THIRD THE HEIGHT OF THE COMPOST SOCK

THE CONSTRUCTION ENTRANCES SHALL BE MAINTAINED IN A CONDITION WHICH WILL PREVENT TRACKING OR FLOW OF MUD ONTO PLIBLIC RIGHTS-OF-WAY, THIS MAY REQUIRE PERIODIC TOP DRESSING OF THE CONSTRUCTION ENTRANCES AS CONDITIONS DEMAND.

THE TEMPORARY PARKING AND STORAGE AREA SHALL BE KEPT IN GOOD CONDITION (SUITABLE FOR PARKING AND STORAGE), THIS MAY REQUIRE PERIODIC TOP DRESSING OF THE TEMPORARY PARKING AS CONDITIONS DEMAND

OUTLET STRUCTURES IN THE SEDIMENTATION BASINS SHALL BE MAINTAINED IN OPERATIONAL CONDITIONS AT ALL TIMES. THE SEDIMENT BASINS/DITCHES SHALL BE CHECKED MONTHLY FOR DÉPTH OF SEDIMENT, SEDIMENT SHALL BE REMOVED FROM SEDIMENT BASINS OR TRAPS WHEN THE DESIGN CAPACITY HAS BEEN REDUCED BY 10% AND AFTER CONSTRUCTION IS COMPLETE

ALL MAINTENANCE OPERATIONS SHALL BE DONE IN A TIMELY MANNER BUT IN NO CASE LATER THAN SEVEN CALENDAR DAYS FOLLOWING THE INSPECTION, DIVERSION DIKES SHALL BE INSPECTED MONTHLY, ANY BREACHES SHALL BE PROMPTLY REPAIRED.

A MAINTENANCE REPORT SHALL BE COMPLETED DAILY AFTER EACH INSPECTION OF THE SEDIMENT AND EROSION CONTROL METHODS. THE REPORTS SHALL BE FILED IN AN ORGANIZED MANNER AND RETAINED ON-SITE DURING CONSTRUCTION AFTER CONSTRUCTION IS COMPLETED. THE REPORTS SHALL BE SAVED FOR AT LEAST THREE YEARS, THE REPORTS SHALL BE AVAILABLE FOR ANY AGENCY THAT HAS JURISDICTION OVER EROSION CONTROL.

ALL REPAIRS MUST BE MADE WITHIN 24 HOURS OF REPORT

THE SUPERINTENDENT SHALL ORGANIZE THE TRAINING FOR INSPECTION PROCEDURES AND PROPER EROSION CONTROL METHODS FOR FMPLOYEES THAT COMPLETE INSPECTIONS AND REPORTS

11. SILT FENCES SHALL BE REPAIRED TO THEIR ORIGINAL CONDITIONS IF DAMAGED. SEDIMENT SHALL BE REMOVED FROM THE SILT FENCES WHEN IT REACHES ONE-HALF THE HEIGHT OF THE SILT FENCE.

### SPILL PREVENTION

THE FOLLOWING ARE THE MATERIAL MANAGEMENT PRACTICES THAT WILL BE USED TO REDUCE THE RISK OF SPILLS OR OTHER ACCIDENTAL EXPOSURE OF MATERIALS AND SUBSTANCES TO STORM WATER RUNOFF

GOOD HOUSEKEEPING

SUPERINTENDENT SHALL INSPECT PROJECT AREA 1.1. DAILY FOR PROPER STORAGE, USE, AND DISPOSAL OF CONSTRUCTION MATERIALS.

STORE ONLY ENOUGH MATERIAL ON SITE FOR PROJECT, COMPLETION.

ALL SUBSTANCES SHOULD BE USED BEFORE 1.3 DISPOSAL OF CONTAINER

ALL CONSTRUCTION MATERIALS STORED SHALL BE ORGANIZED AND IN THE PROPER CONTAINER AND IF POSSIBLE STORED UNDER A ROOF OR PROTECTIVE COVER

PRODUCTS SHALL NOT BE MIXED UNLESS DIRECTED BY THE MANUFACTURER

ALL PRODUCTS SHALL BE USED AND DISPOSED 1.6. OF ACCORDING TO THE MANUFACTURER'S RECOMMENDATIONS

#### HAZARDOUS PRODUCTS

MATERIALS SHOULD BE KEPT IN ORIGINAL CONTAINER WITH LABELS UNLESS THE ORIGINAL CONTAINERS CANNOT BE RESEALED. IF ORIGINAL CONTAINERS CANNOT BE USED, LABELS AND PRODUCT INFORMATION SHALL BE SAVED.

PROPER DISPOSAL PRACTICES SHALL ALWAYS BE FOLLOWED IN ACCORDANCE WITH MANUFACTURER AND LOCAL/STATE REGULATIONS.

#### 2. PRODUCT SPECIFIC PRACTICES

PETROLEUM PRODUCTS MUST BE STORED IN PROPER CONTAINERS AND CLEARLY LABELED. VEHICLES CONTAINING PETROLEUM PRODUCTS SHALL BE PERIODICALLY INSPECTED FOR LEAKS. PRECAUTIONS SHALL BE TAKEN TO AVOID LEAKAGE OF PETROLEUM PRODUCTS ON SITE

THE MINIMUM AMOUNT OF FERTILIZER SHALL BE USED AND MIXED INTO THE SOIL IN ORDER TO LIMIT EXPOSURE TO STORM WATER, FERTILIZERS SHALL BE STORED IN A COVERED SHED. THE CONTENTS OF ANY PARTIALLY USED BAGS OF FERTILIZER SHALL BE TRANSFERRED TO A SEALABLE PLASTIC BIN TO AVOID SPILLS.

PAINT CONTAINERS SHALL BE SEALED AND STORED WHEN NOT IN USE. EXCESS PAINT MUST BE DISPOSED OF IN AN APPROVED MANNER, CONCRETE TRUCKS SHALL NOT BE ALLOWED TO WASH OUT OR DISCHARGE SURPLUS CONCRETE OR DRUM WASH WATER ON

## SPILL CLEANUP

IN ADDITION TO THE GOOD HOUSEKEEPING AND MATERIAL MANAGEMENT PRACTICES DISCUSSED ABOVE, THE FOLLOWING PRACTICES SHALL BE FOLLOWED FOR SPILL PREVENTION AND CLEANUP:

SPILL CLEANUP INFORMATION SHALL BE POSTED ON SITE TO INFORM EMPLOYEES ABOUT CLEANUP PROCEDURES AND RESOURCES.

THE FOLLOWING CLEAN-UP EQUIPMENT MUST BE KEPT ON-SITE NEAR THE MATERIAL STORAGE AREA: GLOVES. MOPS, RAGS, BROOMS, DUST PANS, SAND, SAWDUST, LIQUID ABSORBER, GOGGLES, AND TRASH CONTAINERS

SUFFICIENT OIL AND GREASE ABSORBING MATERIALS. AND FLOTATION BOOMS SHALL BE MAINTAINED ONSITE AND READILY AVAILABLE TO CONTAIN AND CLEAN-UP FUFL OR CHEMICAL SPILLS AND LEAKS

ALL SPILLS SHALL BE CLEANED UP AS SOON AS POSSIBLE WHEN CLEANING A SPILL. THE AREA SHOULD BE WELL

VENTILATED AND THE EMPLOYEE SHALL WEAR PROPER PROTECTIVE COVERING TO PREVENT INJURY.

TOXIC SPILLS MUST BE REPORTED TO THE PROPER AUTHORITY REGARDLESS OF THE SIZE OF THE SPILL

AFTER A SPILL THE PREVENTION PLAN SHALL BE REVIEWED AND CHANGED TO PREVENT FURTHER SIMILAR SPILLS FROM OCCURRING. THE CAUSE OF THE SPILL MEASURES TO PREVENT IT, AND HOW TO CLEAN THE SPILL LIP SHALL BE RECORDED

THE SUPERINTENDENT SHALL BE THE SPILL PREVENTION AND CLEANUP COORDINATOR AND IS RESPONSIBLE FOR THE DAY TO DAY SITE OPERATIONS. THE SUPERINTENDENT ALSO OVERSEES THE SPIL PREVENTION PLAN AND SHALL BE RESPONSIBLE FOR EDUCATING THE EMPLOYEES ABOUT SPILL PREVENTION AND CLEANUP PROCEDURES.

RUIZ

NGINEERS INSPECTORS AND SURVEYORS

R.J.RUIZ & ASSOCIATE INC. dba RUIZ 10101 SW 56 ST MIAMI, FL 33165 800-559-RUIZ WWW.RUIZUSA.COM

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SHARP ENERGY 520 COMMERCE ST SALISBURY, MD 21804 (302) 841-3156 WWW.SHARPENERGY.CO

ESIGNER: LFERNANDE APPROVED BY: RUIZ

25-1770 CONTROL:


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SHEET NO:

C-4002

ISSUED FOR PERMITTING Monday, November 10, 2025



ARM-MOUNTED ON STEEL OR ALUMINUM POLES EITHER

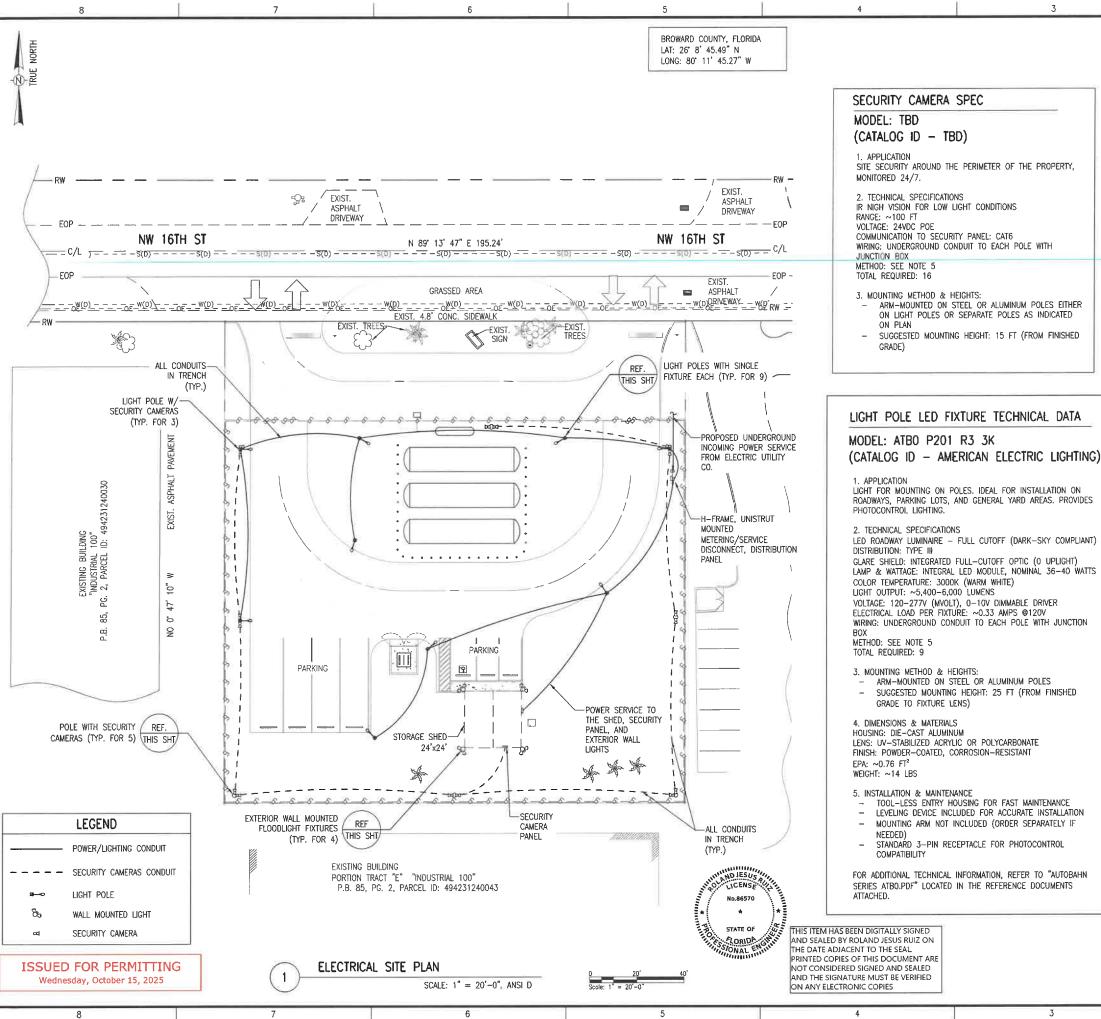ON LIGHT POLES OR SEPARATE POLES AS INDICATED

ARM-MOUNTED ON STEEL OR ALUMINUM POLES

GRADE TO FIXTURE LENS)

COMPATIBILITY

SUGGESTED MOUNTING HEIGHT: 25 FT (FROM FINISHED

TOOL-LESS ENTRY HOUSING FOR FAST MAINTENANCE

LEVELING DEVICE INCLUDED FOR ACCURATE INSTALLATION

MOUNTING ARM NOT INCLUDED (ORDER SEPARATELY IF

STANDARD 3-PIN RECEPTACLE FOR PHOTOCONTROL

ON PLAN

GRADE)

NOTES

- 1. ENTIRE INSTALLATION SHALL BE IN ACCORDANCE WITH THE LATEST EDITION OF THE NATIONAL ELECTRIC CODE (NEC), ALL LOCAL & STATE CODES, RULES, AND ORDINANCES WITH ALL AUTHORITIES HAVING JURISDICTION.
- ALL EXTERIOR LIGHTING FIXTURES SHALL BE INSTALLED PER MANUFACTURER'S SPECIFICATIONS AND IN COMPLIANCE WITH NEC, NFPA 70, AND ALL APPLICABLE LOCAL ELECTRICAL CODES.
  ALL LIGHTING FIXTURES SHALL BE FULL-CUTOFF TYPE TO REDUCE
- GLARE AND SPILLOVER BEYOND PROPERTY BOUNDARIES.
- ALL ELECTRICAL EQUIPMENT AND FIXTURES INSTALLED OUTDOORS SHALL BE RATED FOR WET AND CORROSIVE ENVIRONMENTS.
- ALL CONDUIT AND WIRING SHALL BE INSTALLED UNDERGROUND (SUBTERRANEAN METHOD) IN PVC COATED RIGID STEEL CONDUIT WITH THE SMALL PORTIONS ABOVE GRADE AS RIGID GALVANIZED STEEL. ROUTING SHOWN DIAGRAMMATICALLY ON THIS DRAWING.
- COORDINATION WITH FLORIDA POWER & LIGHT (FPL) SHALL BE REQUIRED FOR FINAL POWER SERVICE CONNECTION.
- ALL FIXTURES WITHIN VEHICULAR CIRCULATION AREAS SHALL MEET CLEARANCE AND HEIGHT REQUIREMENTS.
- PHOTOCELL OR TIMER SYSTEM SHALL CONTROL ALL EXTERIOR LIGHTING UNLESS OTHERWISE SPECIFIED.
- ALL LIGHTING AND CONDUIT WITHIN CLASSIFIED HAZARDOUS AREAS SHALL COMPLY WITH NFPA 70 (NEC), ARTICLES 500-505, AND NFPA 58
- 10. CONTRACTOR SHALL FIELD-VERIFY MOUNTING CONDITIONS AND FIXTURE LOCATIONS PRIOR TO INSTALLATION.
- 11. REFER TO SHEET E-1002 (LIGHTING PHOTOMETRIC PLAN) FOR THE SITE PHOTOMETRIC LAYOUT AND CORRESPONDING PHOTOMETRIC REPORT.

## LIGHTING POLE SPACING NOTE:

ALL EXTERIOR LIGHTING FIXTURES HAVE BEEN STRATEGICALLY DISTRIBUTED THROUGHOUT THE SITE TO ENSURE THAT THE DISTANCE BETWEEN ANY TWO POLES DOES NOT EXCEED 80 FEET, IN ACCORDANCE WITH THE APPROVED PHOTOMETRIC LAYOUT AND SPACING CRITERIA

#### WALL MOUNT LED FIXTURE TECHNICAL DATA

MODEL: HGX LED 2RH ALO SWW2 120 PIR WH (CATALOG ID - LITHONIA LIGHTING)

DUAL-HEAD LED FLOODLIGHT FOR WALL-MOUNTED SECURITY LIGHTING, IDEAL FOR INSTALLATION ON BUILDING CORNERS, PEDESTRIAN ENTRANCES, AND SERVICE AREAS. PROVIDES MOTION-ACTIVATED AND DUSK-TO-DAWN LIGHTING.

2. TECHNICAL SPECIFICATIONS

POWER CONSUMPTION: 26 WATTS TOTAL (DUAL HEADS) LIGHT OUTPUT: 2,150-2600 LUMENS (SELECTABLE) COLOR TEMPERATURE: 3000K (SELECTABLE) MOUNTING: WALL-MOUNTED FIXTURE FINISH: WHITE

VOLTAGE: 120V

ELECTRICAL LOAD PER FIXTURE: ~0.22 AMPS @ 120V SENSOR: INTEGRATED MOTION SENSOR AND DUSK-TO-DAWN PHOTOCELL DETECTION RANGE: UP TO 40 FT MOTION SENSING DISTANCE

LIGHT COVERAGE: WIDE-AREA DUAL ADJUSTABLE HEADS OPERATING TEMP: SUITABLE FOR OUTDOOR USE INGRESS PROTECTION: WET LOCATION RATED CERTIFICATIONS: UL LISTED
TOTAL REQUIRED: 4 DUAL HEADS

- 3. MOUNTING METHOD & HEIGHTS:
- MOUNTS TO STANDARD WALL BOX OR SURFACE
- SUGGESTED MOUNTING HEIGHT IS 10 FT (FROM FINISHED GRADE TO FIXTURE LENS)

4. DIMENSIONS & MATERIALS
DIMENSIONS: APPROX. 7.56" W × 4.96" L × 4.53" H
HOUSING: CAST-ALUMINUM

- ADJUSTABLE LAMP HEADS FOR DIRECTIONAL AIMING AUTOMATIC OPERATION WITH NO MANUAL SWITCH REQUIRED
- LOW-MAINTENANCE, LONG-LIFE LED SOURCE
- FOR EXTERIOR USE ONLY
- RECOMMENDED FOR SECURITY AND GENERAL BUILDING PERIMETER LIGHTING
- SENSOR SETTINGS MAY BE CUSTOMIZED PER LOCATION NEEDS

FOR ADDITIONAL TECHNICAL INFORMATION, REFER TO "LITHONIA\_HGX\_LED\_2RH\_ALO\_SWW2\_120\_PIR\_WH.PDF" LOCATED IN THE REFERENCE DOCUMENTS ATTACHED.

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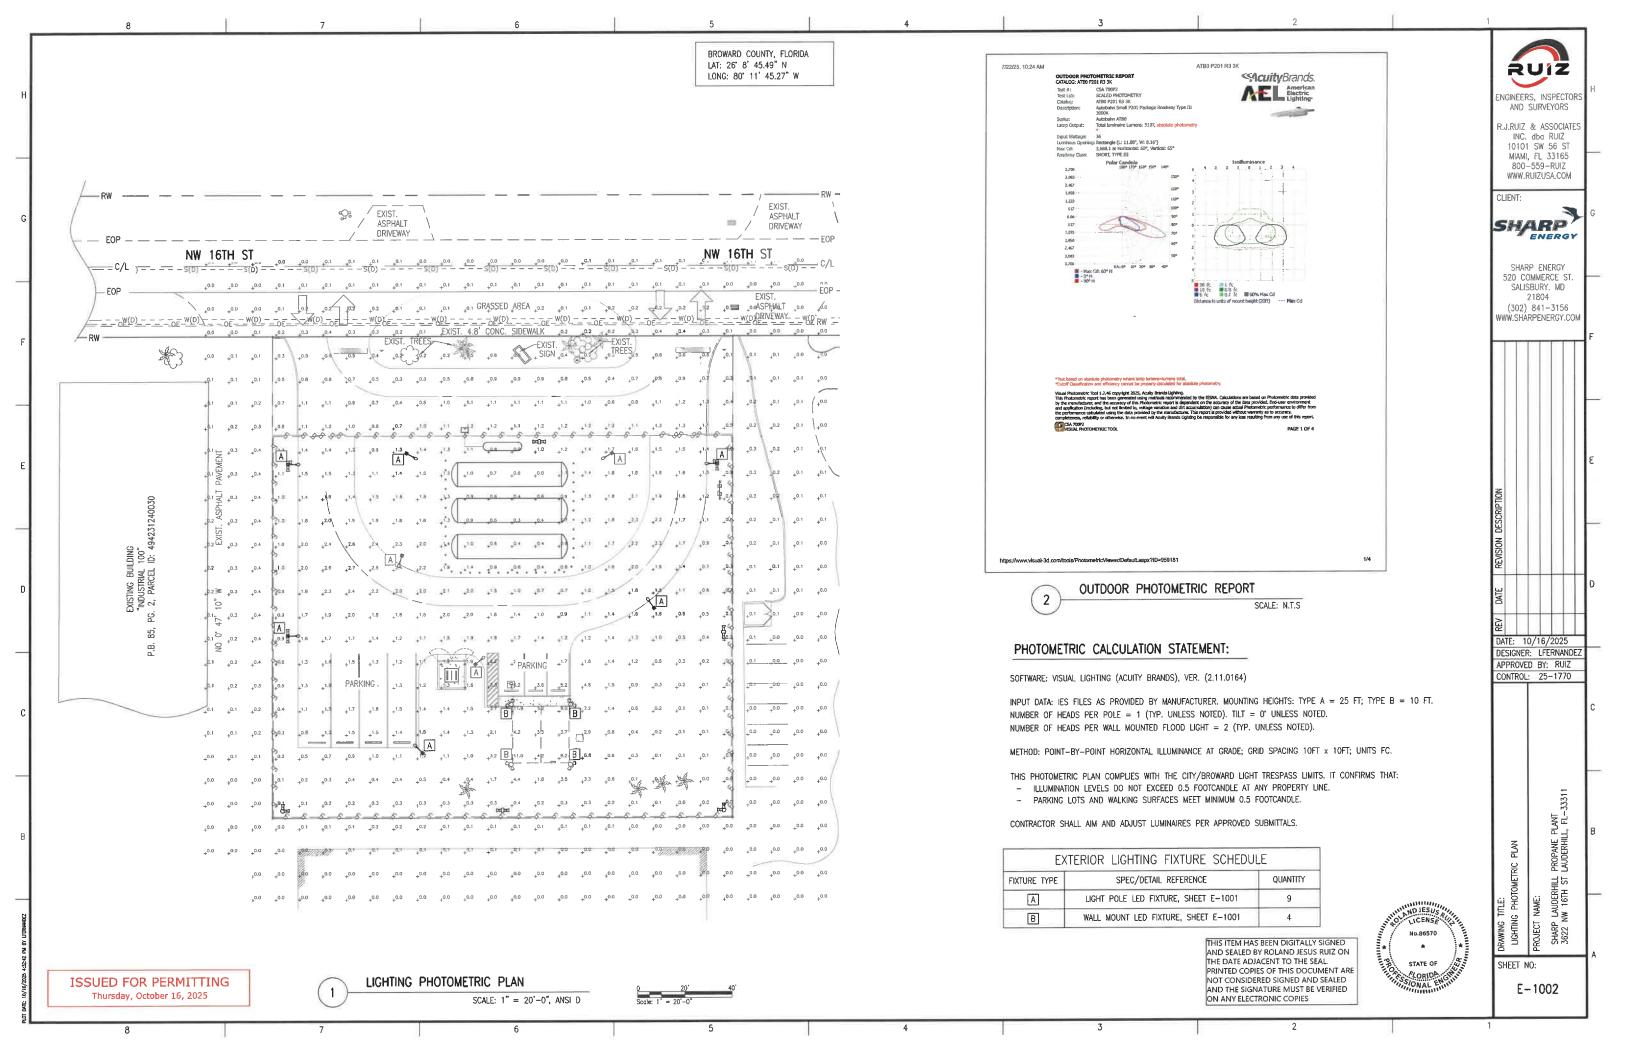
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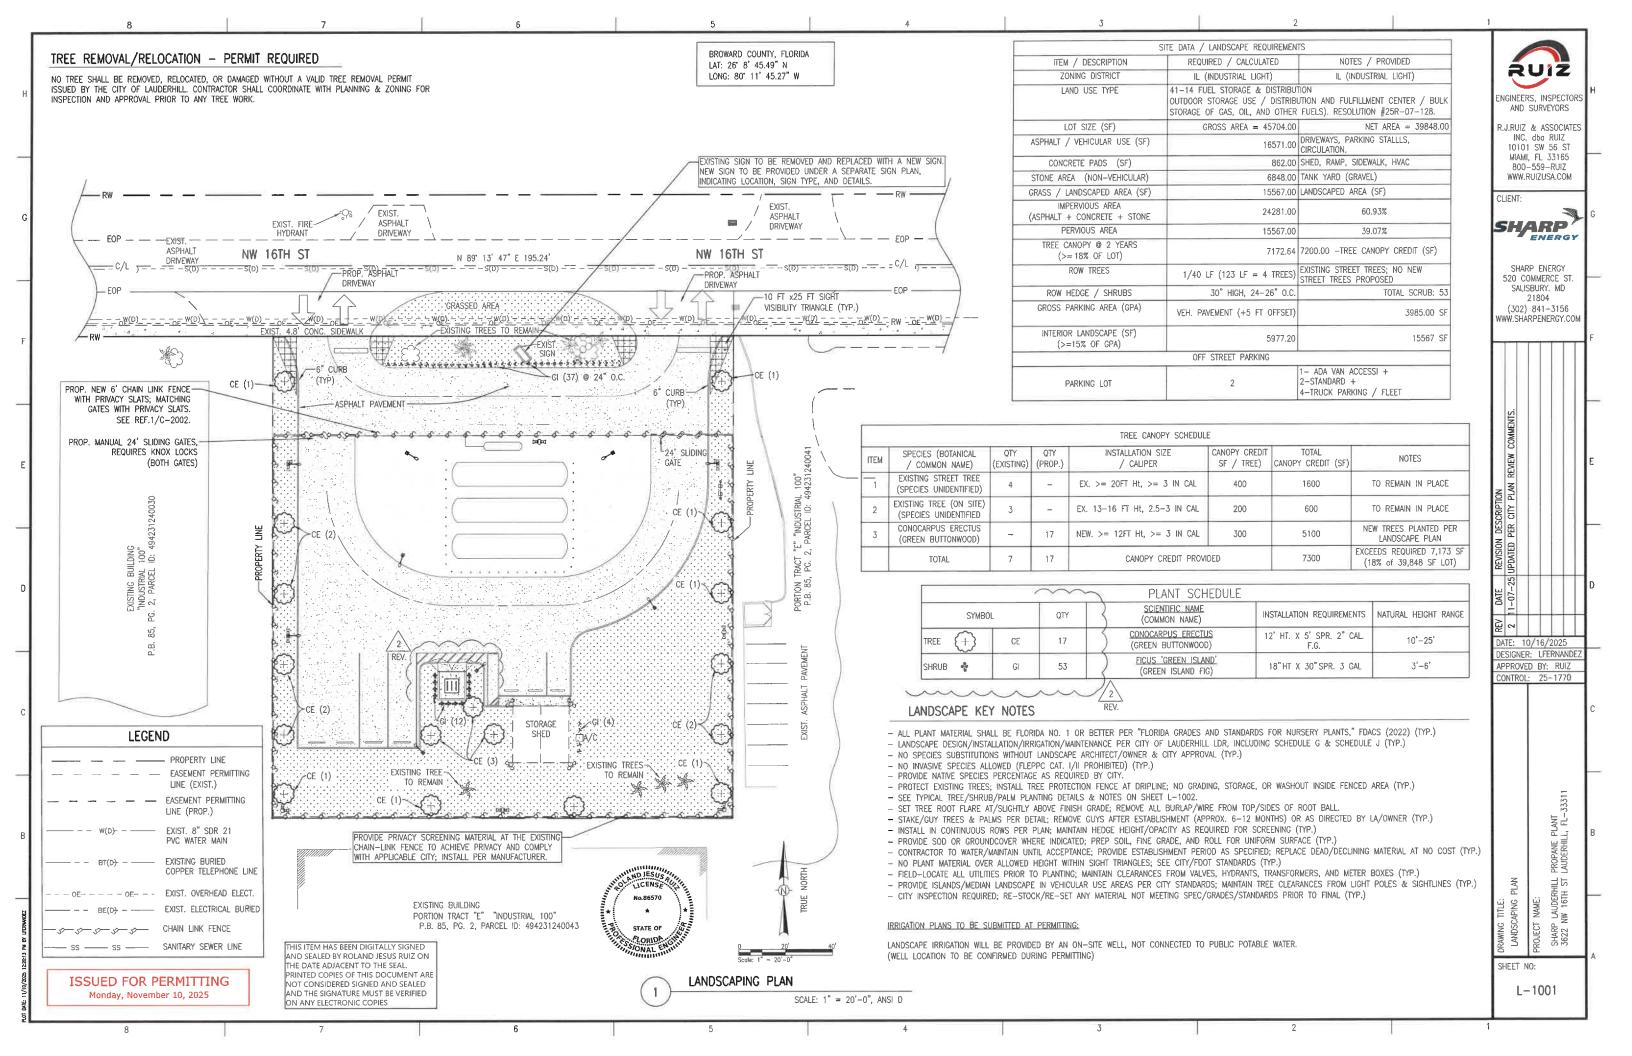
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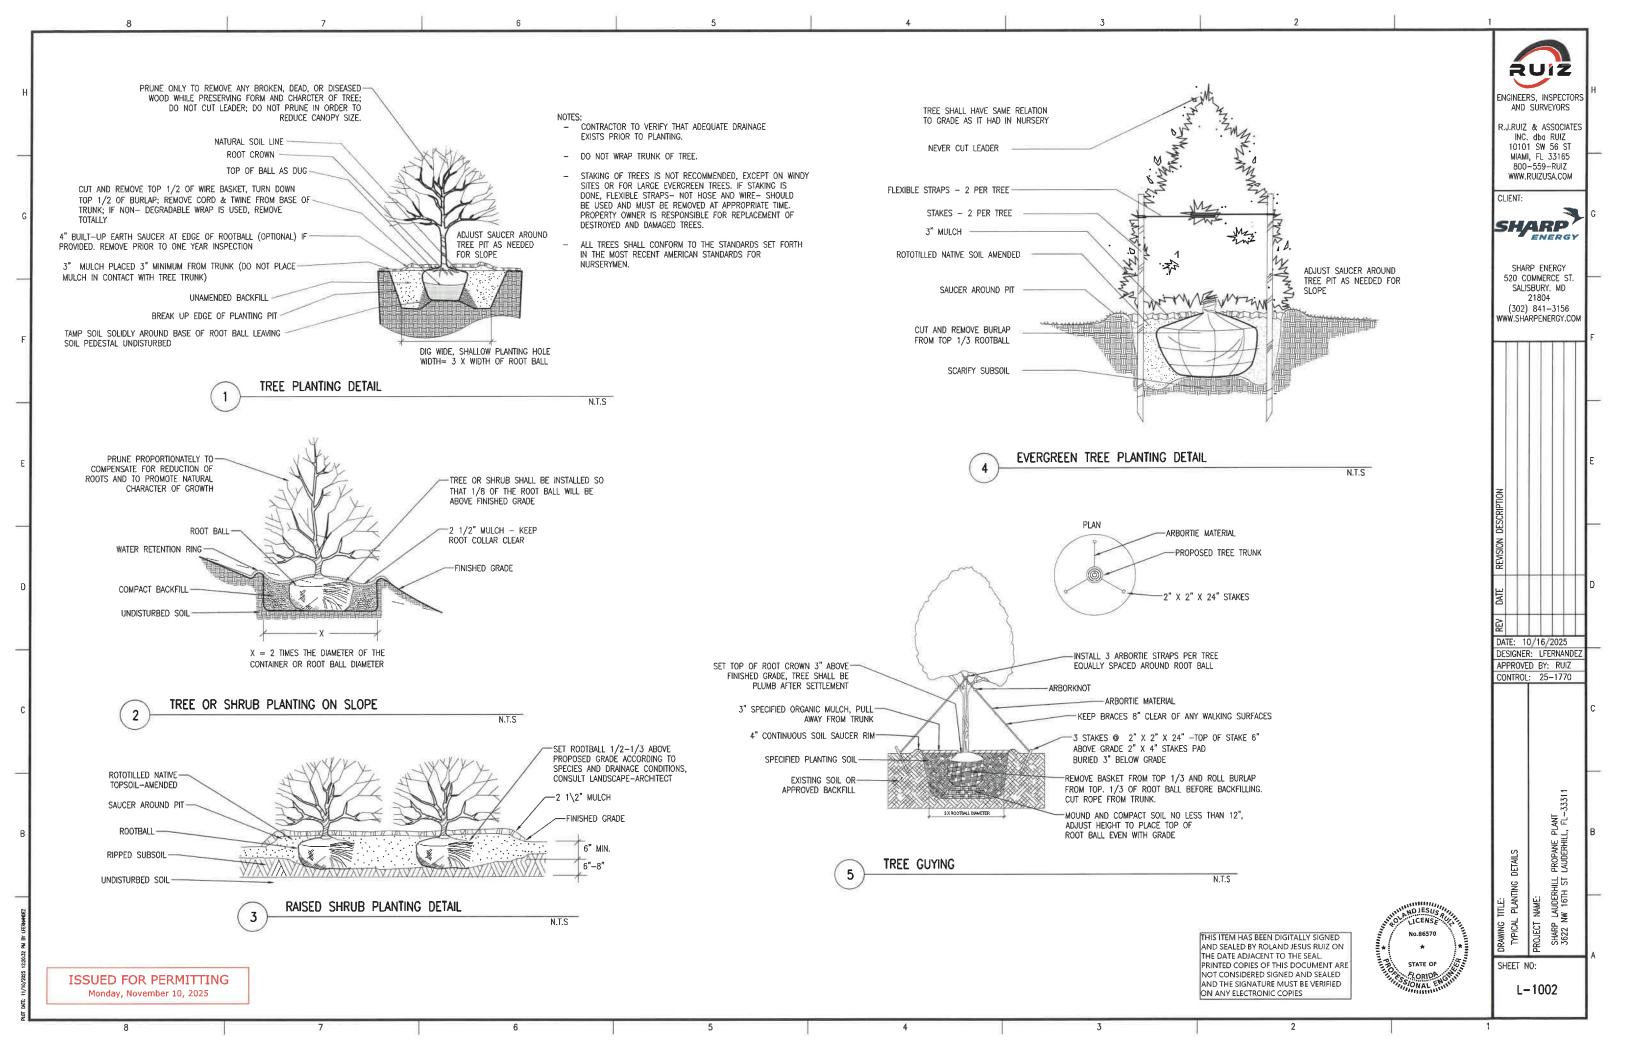
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E-1001

SHEET NO:







LIFE SAFETY / FIRE NOTES BROWARD COUNTY, FLORIDA LAT: 26° 8' 45.49" N RUIZ LONG: 80° 11' 45.27" W NEW AND EXISTING BUILDINGS SHALL HAVE APPROVED ADDRESS NUMBERS PLACED IN A POSITION TO BE PLAINLY LEGIBLE AND VISIBLE FROM THE STREET OR ROAD FRONTING THE PROPERTY. ADDRESS NUMBERS SHALL CONTRAST WITH THEIR NGINEERS, INSPECTORS BACKGROUND, ADDRESS NUMBERS SHALL BE ARABIC NUMERALS OR ALPHABET LETTERS (FFPC 10.11.1.1). AND SURVEYORS 2. STRUCTURES UNDERGOING CONSTRUCTION, ALTERATION, OR DEMOLITION OPERATIONS, INCLUDING THOSE IN UNDERGROUND R.I.RUIZ & ASSOCIATES LOCATIONS, SHALL COMPLY WITH NATIONAL FIRE PROTECTION ASSOCIATION 241, STANDARD FOR SAFEGUARDING INC. dba RUIZ CONSTRUCTION, ALTERATION, AND DEMOLITION OPERATIONS (FFPC 16.1.1) 10101 SW 56 ST EXIST. FIRE MIAMI, FL 33165 HYDRANT 3. FIRE DEPARTMENT ACCESS ROADS PROVIDED IN ACCORDANCE WITH 18.2.3 SHALL BE PROVIDED AT THE START OF A 800-559-RUIZ EXIST FIRE PROJECT AND SHALL BE MAINTAINED THROUGHOUT CONSTRUCTION. PERMANENT FIRE DEPARTMENT ACCESS ROAD MARKINGS WWW.RUIZUSA.COM HYDRANT SHALL NOT BE REQUIRED UNTIL THE BUILDING IS COMPLETE OR OCCUPIED FOR USE (FFPC 16.1.4). ACCESS BOX(ES). THE AHJ SHALL HAVE THE AUTHORITY TO REQUIRE AN ACCESS BOX(ES) TO BE INSTALLED IN AN ACCESSIBLE LOCATION WHERE ACCESS TO OR WITHIN A STRUCTURE OR AREA IS DIFFICULT BECAUSE OF SECURITY. PROVIDE EXIST. EXIST, FIRE EXIST. ASPHALT HYDRANT ASPHALT "THE KNOX COMPANY" FOR LOCKING DEVICES IN ACCORDANCE WITH THE CITY OF LAUDERHILL REQUIREMENTS (FFPC SHARP DRIVEWAY DRIVEWAY 18.2.2.1). KNOX LOCKS MAY BE NECESSARY FOR GATE ACCESS. EOP NW 16TH ST NW 16TH ST THE TURNING RADIUS OF A FIRE DEPARTMENT ACCESS ROAD SHALL BE APPROVED BY THE AHJ (FFPC 18.2.3.5.3) A FIRE N 89° 13' 47" E 195.24' RESCUE EMERGENCY ACCESS ROAD SHALL HAVE A MINIMUM INSIDE TURNING RADIUS OF FORTY (40) FEET WITH A TWELVE SHARP ENERGY \_\_\_C/L <del>\_\_\_</del>\_ PROP. ASPHALT PROP. ASPHALT 520 COMMERCE ST. (12) FOOT CLEAR SWEEP AND AN OUTSIDE TURNING RADIUS OF FIFTY-TWO (52) FEET. FIRE DEPARTMENT ACCESS ROADS DRIVEWAY DRIVEWAY SALISBURY. MD SHALL HAVE AN UNOBSTRUCTED VERTICAL CLEARANCE OF NOT LESS THAN THIRTEEN (13) FEET SIX INCHES (6) (4.1 M) -EOP 21804 R40 00' R40.00' (FFPC 18.2.3.5.1.2) GRASSED AREA (302) 841-3156 48.63 WWW.SHÁRPENERGY.COI DRIVING LANES SHALL HAVE A MINIMUM CLEAR WIDTH OF TWENTY-FOUR (24) FEET FOR TWO-WAY TRAFFIC, FIFTEEN (15) EXIST, 4.8' CONC. SIDEWALK FEET FOR ONE-WAY TRAFFIC AND TWELVE (12) FEET FOR DRIVE-THRU/DROP-OFF TRAFFIC. WHEN PARKING SPACES ARE · TREFS PROVIDED AT SIXTY (6) DEGREES ANGLE, THE ONE-WAY DRIVING LAND SHALL BE A MINIMUM EIGHTEEN (18) FEET CLEAR. A 24-INCH WIDE WHITE STOP BAR, ALONG WITH TWENTY-FIVE (25) FEET OF DOUBLE YELLOW LINES, SHALL BE PROVIDED 24 INCH WIDE STOP BAR WITH DOUBLE YELLOW LINES TO REMAIN R40' AT THE END OF EACH DRIVING LANE (LDR SCHEDULE L 3.03 A 1 E). (SEE PAVEMENT MARKING PLANS) (4) PROTECTIVE BOLLARDS 24' SLIDING GATE SEE REF.3/C-2004 7. WHERE A GATE IS INSTALLED FOR VEHICULAR ACCESS CONTROL AND AN ELECTRIC OPENER IS IN USE, FIRE DEPARTMENT -6" CURB 6" CURB PROP. MANUAL 24' SLIDING ACCESS IS REQUIRED THROUGH THE USAGE OF A KNOX KEY SWITCH AND CLICK-2-ENTER SYSTEM. (BROWARD COUNTY GATES PROVIDE KNOX LOCKS (TYP) REF.1 LPG AUTOGAS DISPENSER-AMENDMENTS F-109.9.3). (TYP. BOTH GATES) C-2002 REMOVABLE CPTED PRINCIPLES NARRATIVE BOLLARDS ON ALL SIDES - I PG STORAGE TANK SURROUNDING TANKS LINE NATURAL SURVEILLANCE: 6"ø, AT 4' O.C. SEE REF.1 SHEET A-1003 -- 24.00' 30,000 GAL 10.28 SITE DESIGN PROMOTES VISIBILITY AND OPEN SIGHT LINES. LED LIGHTING IS PROVIDED AROUND DRIVE AISLES, DUMPSTER ENCLOSURE, AND LPG TANK STORAGE AREA TO ELIMINATE CONCEALED SPACES. ALL FENCING AND LANDSCAPING ARE DESIGNED LPG STORAGE TANK .5.00' AND MAINTAINED TO PRESERVE CLEAR VIEWS BETWEEN PUBLIC AREAS, DRIVEWAYS, FLECTRICAL & 30,000 GAL AND BUILDING ACCESS POINTS. SECURITY PANELS LPG STORAGE TANK 70.00 NATURAL ACCESS CONTROL: 5.00 FUTURE 30 000 GAI PUBLIC ACCESS TO THE FRONT DISPENSER AREA IS OPEN AND CLEARLY DEFINED FOR VEHICLE ENTRY AND EXIT ALONG NW 16TH LPG STORAGE TANK STREET, ALLOWING SAFE TWO-WAY CIRCULATION THROUGH THE SITE. SEPARATE FENCING AND GATED ACCESS BEHIND THE DISPENSER RESTRICT ENTRY TO THE BULK STORAGE AREA WITH THE THREE (3) 30,000-GALLON LPG TANKS. BOLLARDS ARE PROVIDED AROUND THE DISPENSER AND TANKS TO PREVENT VEHICLE IMPACT AND TO GUIDE TRAFFIC FLOW AWAY FROM RESTRICTED AREAS. R64 00' -0 3. TERRITORIAL REINFORCÉMENT: FENCING, BOLLARDS, SIGNAGE, AND LANDSCAPE BUFFERS CLEARLY DEFINE THE LIMITS OF THE PROPERTY AND CONVEY OWNERSHIP. THE OPERATIONAL ZONES (LPG YARD AND DUMPSTER ENCLOSURE) ARE VISIBLY DISTINGUISHED FROM PUBLIC AREAS SUCH AS THE 12.00' 12.00' 12.00' PROP. NEW 6' CHAIN LINK ACCESS DRIVE AND PARKING SPACES. ALL IDENTIFICATION AND SAFETY SIGNS ARE POSTED PER CODE TO REINFORCE AUTHORIZED FENCE WITH PRIVACY SLATS: DESIGNER: LFERNANDE MATCHING GATES WITH PRIVACY APPROVED BY: RUIZ SLATS. SEE SHEET C-2003. CONTROL: 25-1770 PROP. 4' CONC. SIDEWALK. (ACCESS WALK) 1.00 A CONTINUOUS MAINTENANCE PROGRAM WILL ENSURE THAT LIGHTING, SIGNAGE, FENCING, AND LANDSCAPE ARE KEPT IN GOOD CONDITION. THE PROPERTY OWNER / FACILITY OPERATOR SHALL BE RESPONSIBLE FOR IMPLEMENTING AND MAINTAINING ALL SITE SAFETY AND CLEANLINESS MEASURES. VEGETATION WILL BE TRIMMED REGULARLY TO PRESERVE VISIBILITY AND REMOVE VISUAL ADA CONC. RAMP OBSTRUCTIONS. DAMAGED EQUIPMENT, LIGHTS, OR DEBRIS WILL BE REPAIRED OR REMOVED PROMPTLY TO MAINTAIN A SAFE AND SLOPE 8.33% MAX. SHED SEE REF.2/A-1004) ORDERLY APPEARANCE. 5. ACTIVITY SUPPORT: STORAGE SHED ROOF CONSISTS OF THE SITE'S 24-HOUR OPERATION AND REGULAR DELIVERIES PROVIDE CONSISTENT LEGITIMATE ACTIVITY AND OBSERVATION. EMPLOYEE LIGHTWEIGHT ROOFING ASPHALT 3 TAB SHINGLES OVER 5/8" PLY AND 30# FELT PRESENCE, FUELING OPERATIONS, AND VEHICLE MOVEMENT SUPPORT NATURAL SURVEILLANCE AND DISCOURAGE ILLICIT BEHAVIOR. THE PROPERTY'S FUNCTION AS AN ACTIVE COMMERCIAL FACILITY PROMOTES SAFETY AND OVERSIGHT THROUGH DAILY USE. NOTE: SEE LANDSCAPE PLAN AND LIGHTING PLAN FOR ADDITIONAL SECURITY FEATURES AND MAINTENANCE COORDINATION. STATE OF PROPANE LAUDERHIL LEGEND 크 EXISTING BUILDING THIS ITEM HAS BEEN DIGITALLY SIGNED PORTION TRACT "E" "INDUSTRIAL 100" LAUDERH NW 16TH - PROPERTY LINE AND SEALED BY ROLAND JESUS RUIZ ON P.B. 85, PG. 2, PARCEL ID: 494231240043 IG TITLE: SAFETY THE DATE ADJACENT TO THE SEAL. GENERAL DIRECTION OF PRINTED COPIES OF THIS DOCUMENT ARE CIRCULATION NOT CONSIDERED SIGNED AND SEALED SHARP 3622 EXIST, 8" SDR 21 PVC WATER MAIN AND THE SIGNATURE MUST BE VERIFIED ON ANY ELECTRONIC COPIES EXISTING BURIED COPPER TELEPHONE LINE SHEET NO: - OE- - - - OE- - - EXIST. OVERHEAD ELECT. **ISSUED FOR PERMITTING** LIFE SAFETY PLAN LS-1001 Monday, November 10, 2025 SCALE: 1" = 20'-0", ANSI D